
STATE OF NORTH CAROLINA DEPARTMENT OF TRANSPORTATION

WASHINGTON COUNTY CRESWELL MAINTENANCE YARD

ON SITE SEPTIC SYSTEM REPAIRS CONSTRUCTION DOCUMENTS

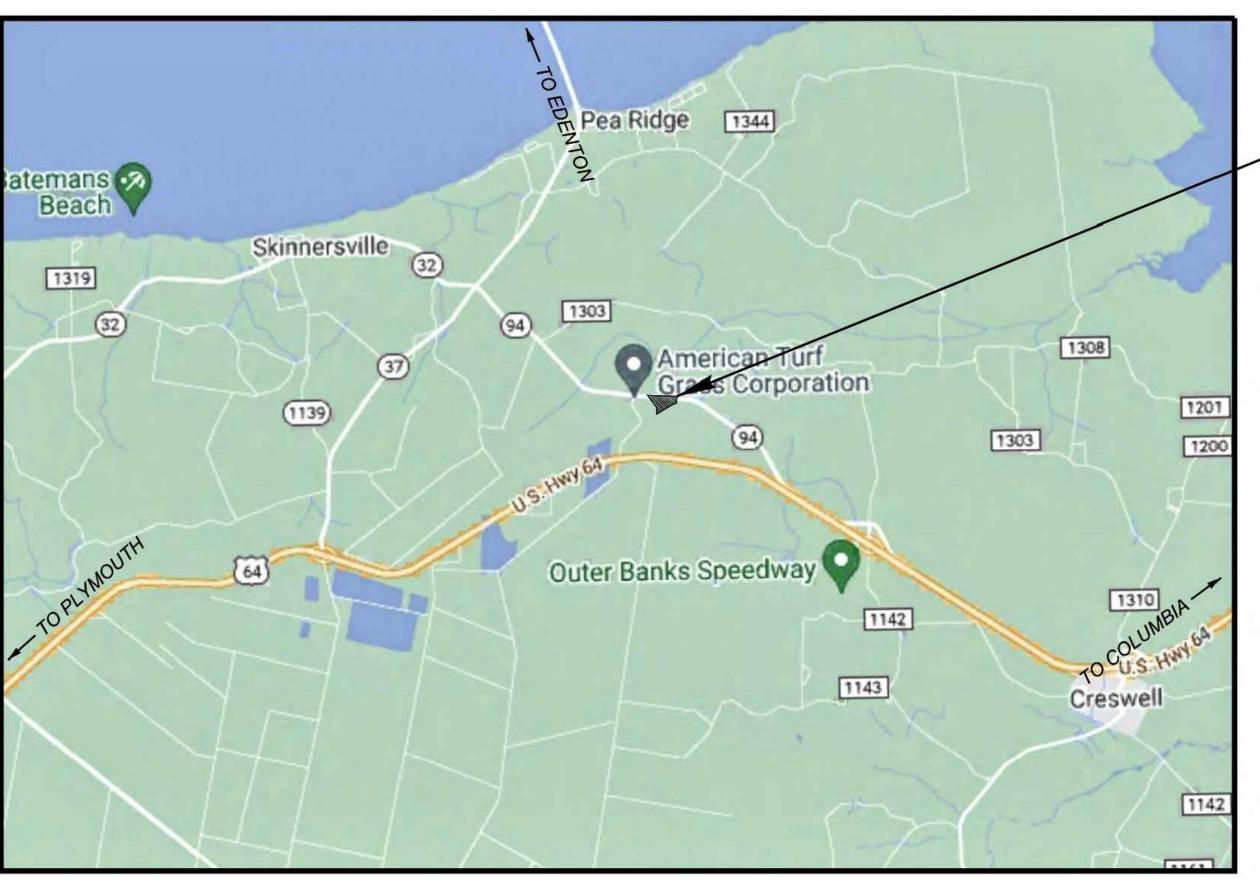

PROJECT SITE

CIVIL ENGINEER

VAUGHN & MELTON

1318–F PATTON AVE.

ASHEVILLE, NC 28806

828–253–2796

INDEX OF SHEETS

GENERAL

CS1.0 COVER SHEET

CIVIL

C8.0

C1.0 EXISTING SITE LAYOUT PLAN
C2.0 CONTOURS

5 C3.0 PROPOSED SITE LAYOUT PLAN
C4.0 PROPOSED SEPTIC AND PUMP TANK LAYOUT PLAN
C5.0 PROPOSED SEPTIC AND PUMP TANK DETAILS
C6.0 PROPOSED DRAINFIELD PLAN VIEW
C6.1 PROPOSED DRAINFIELD SECTION & DETAILS
C7.0 PROPOSED FORCE MAIN NO.1 AND NO.2 PROFILES

ELECTRICAL

E1.0 ELECTRICAL SITE LAYOUT PLAN

CONSTRUCTION DETAILS

E2.0 ELECTRICAL DETAILS

THE PROJECT CONSISTS OF REPAIRS TO THE EXISTING ON-SITE WASTE WATER SYSTEM SERVING THE WASHINGTON COUNTY DOT MAINTENANCE YARD. A NEW SEPTIC TANK, PUMP TANK, FORCE MAINS AND A NEW LOW PRESSURE PIPE DRAINFIELD SYSTEM ARE PROPOSED TO REPLACE THE EXISTING ON SITE DISPOSAL SYSTEM.



CRESWELL SEPTIC SYSTEM SCO ID#22-25127-01A



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SCALE: AS SHOWN


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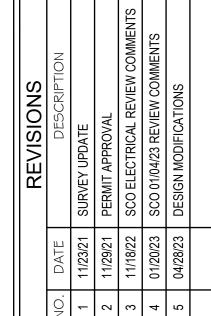
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COVER SHEET

DRAWING NO:





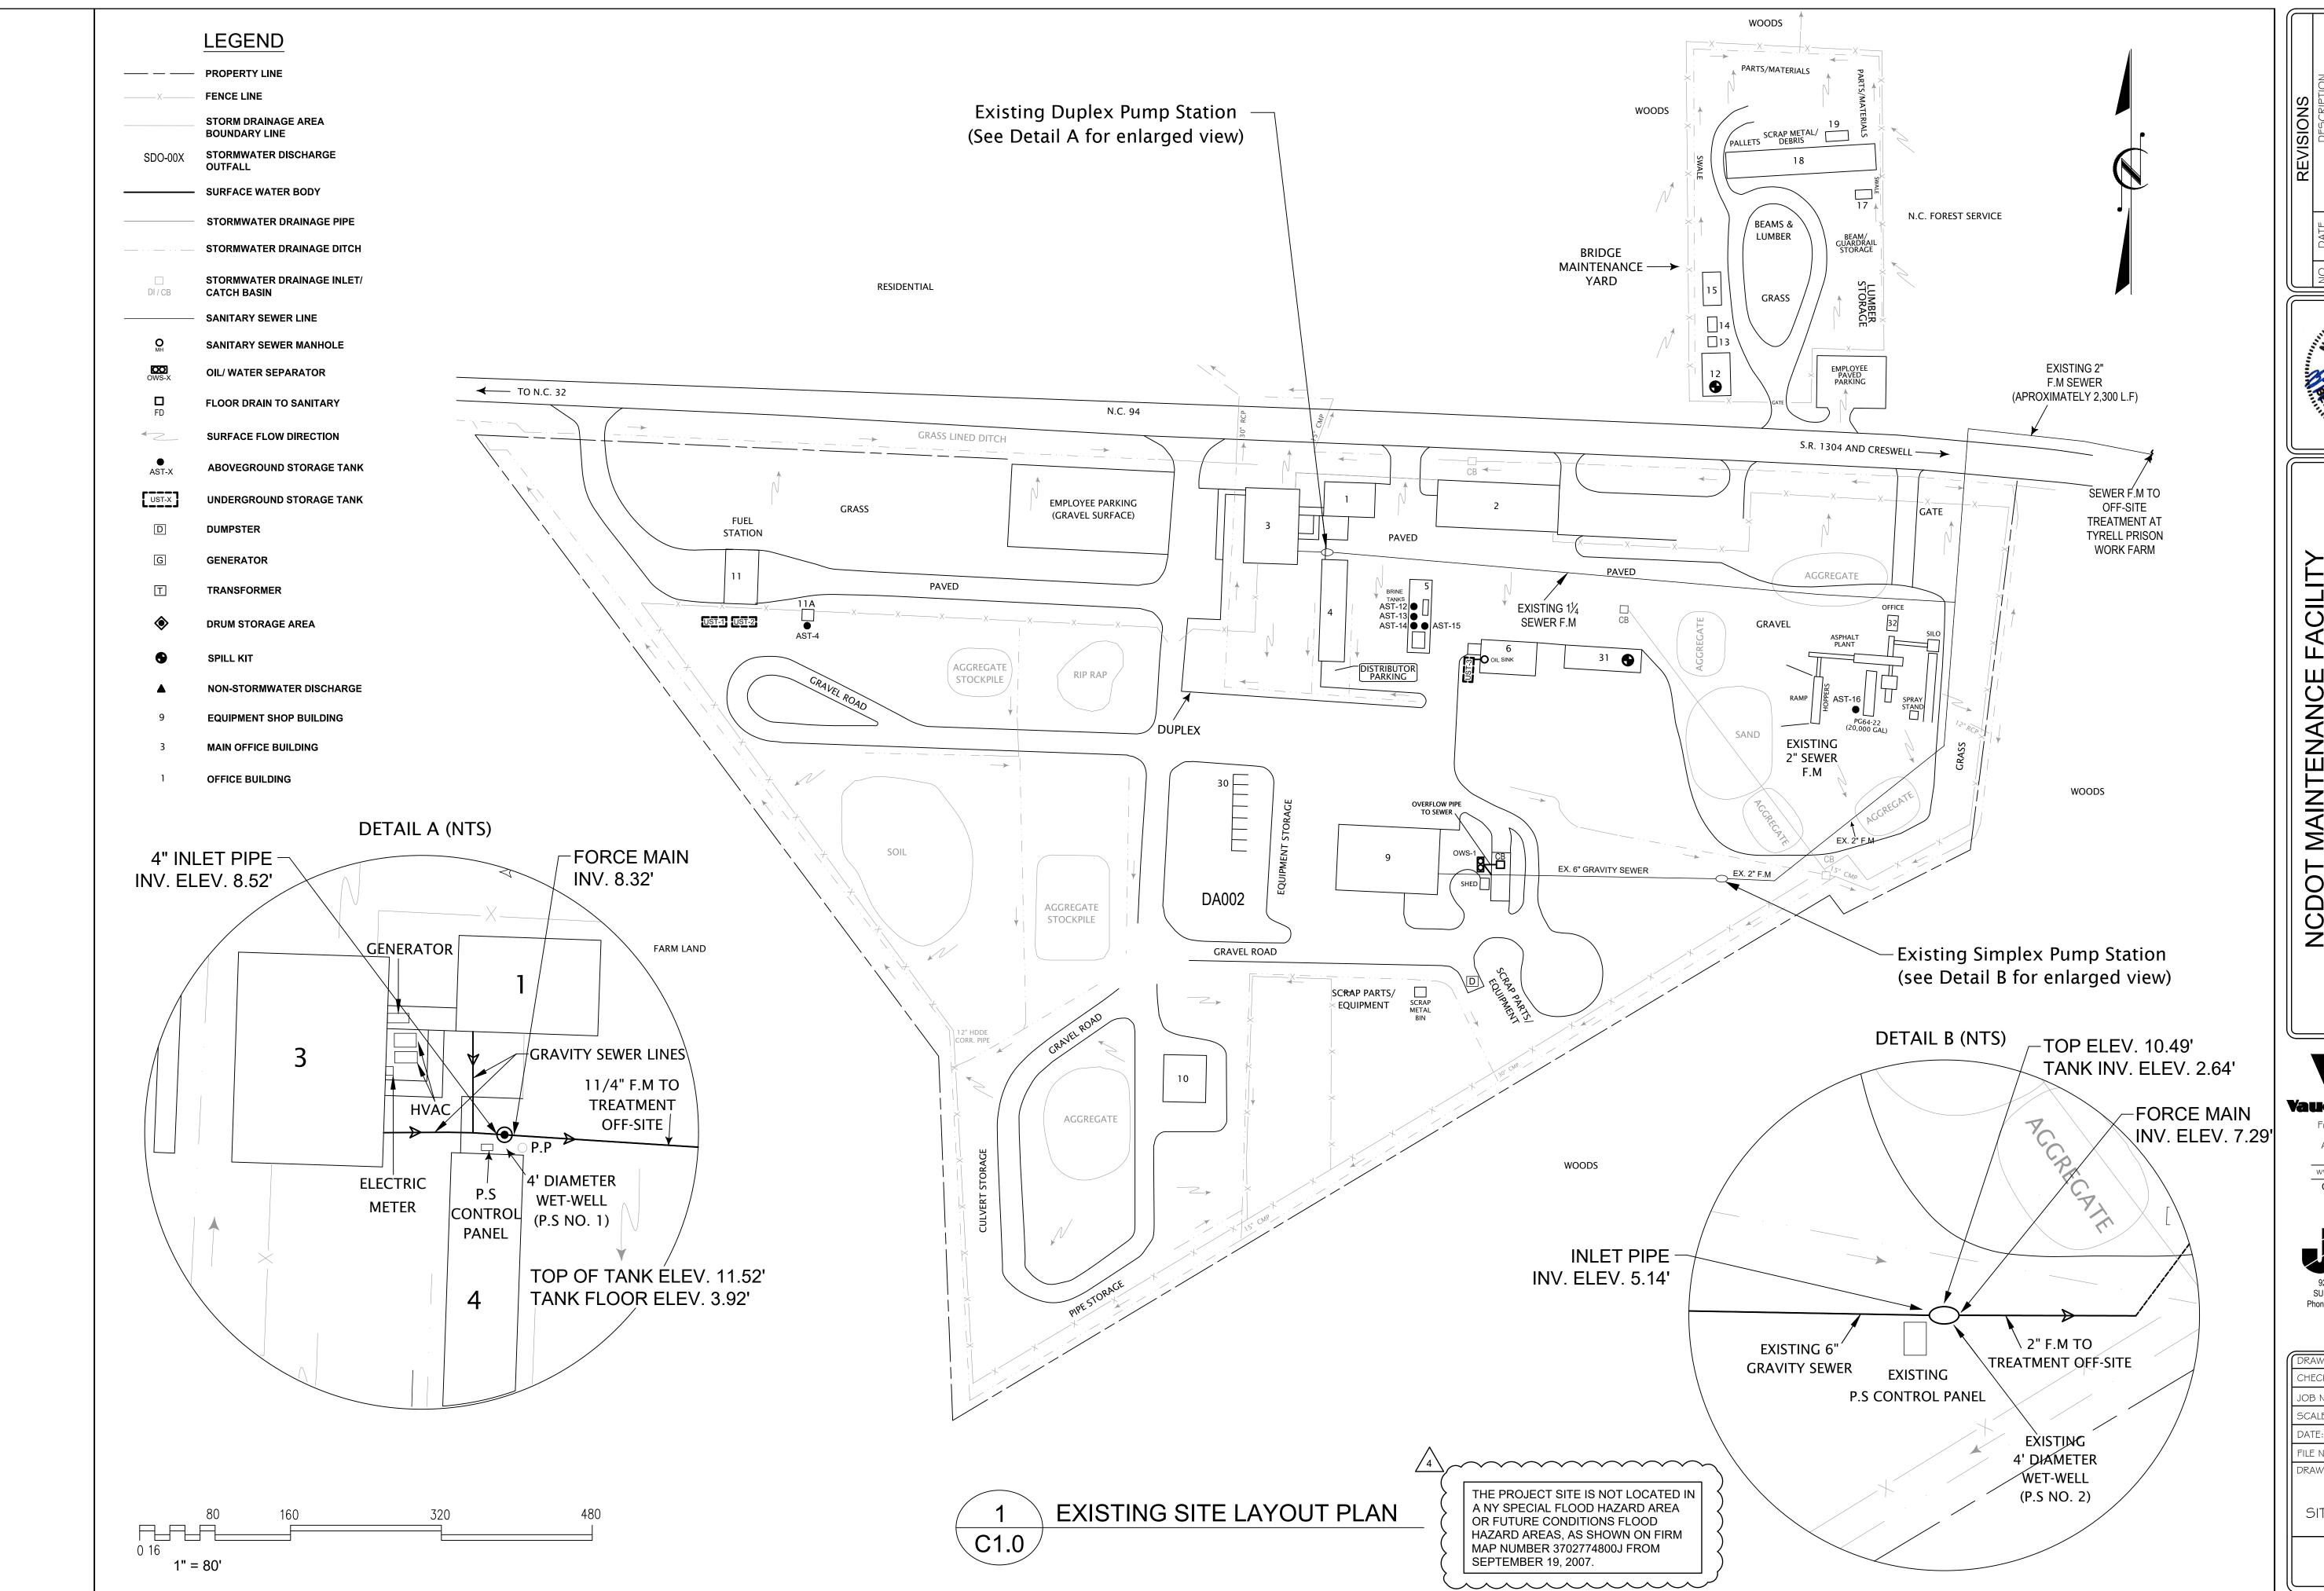


NCDOT MAINTENANCE FACILITY
CRESWELL SEPTIC SYSTEM
SCO ID#22-25127-01A





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SCALE:	AS SHOWN	
DATE:	OCTOBER 2021	
FILE NAME	: CI.O Ex Site Layout Plan.dw	
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EXISTING SITE LAYOUT PLAN DRAWING NO:		





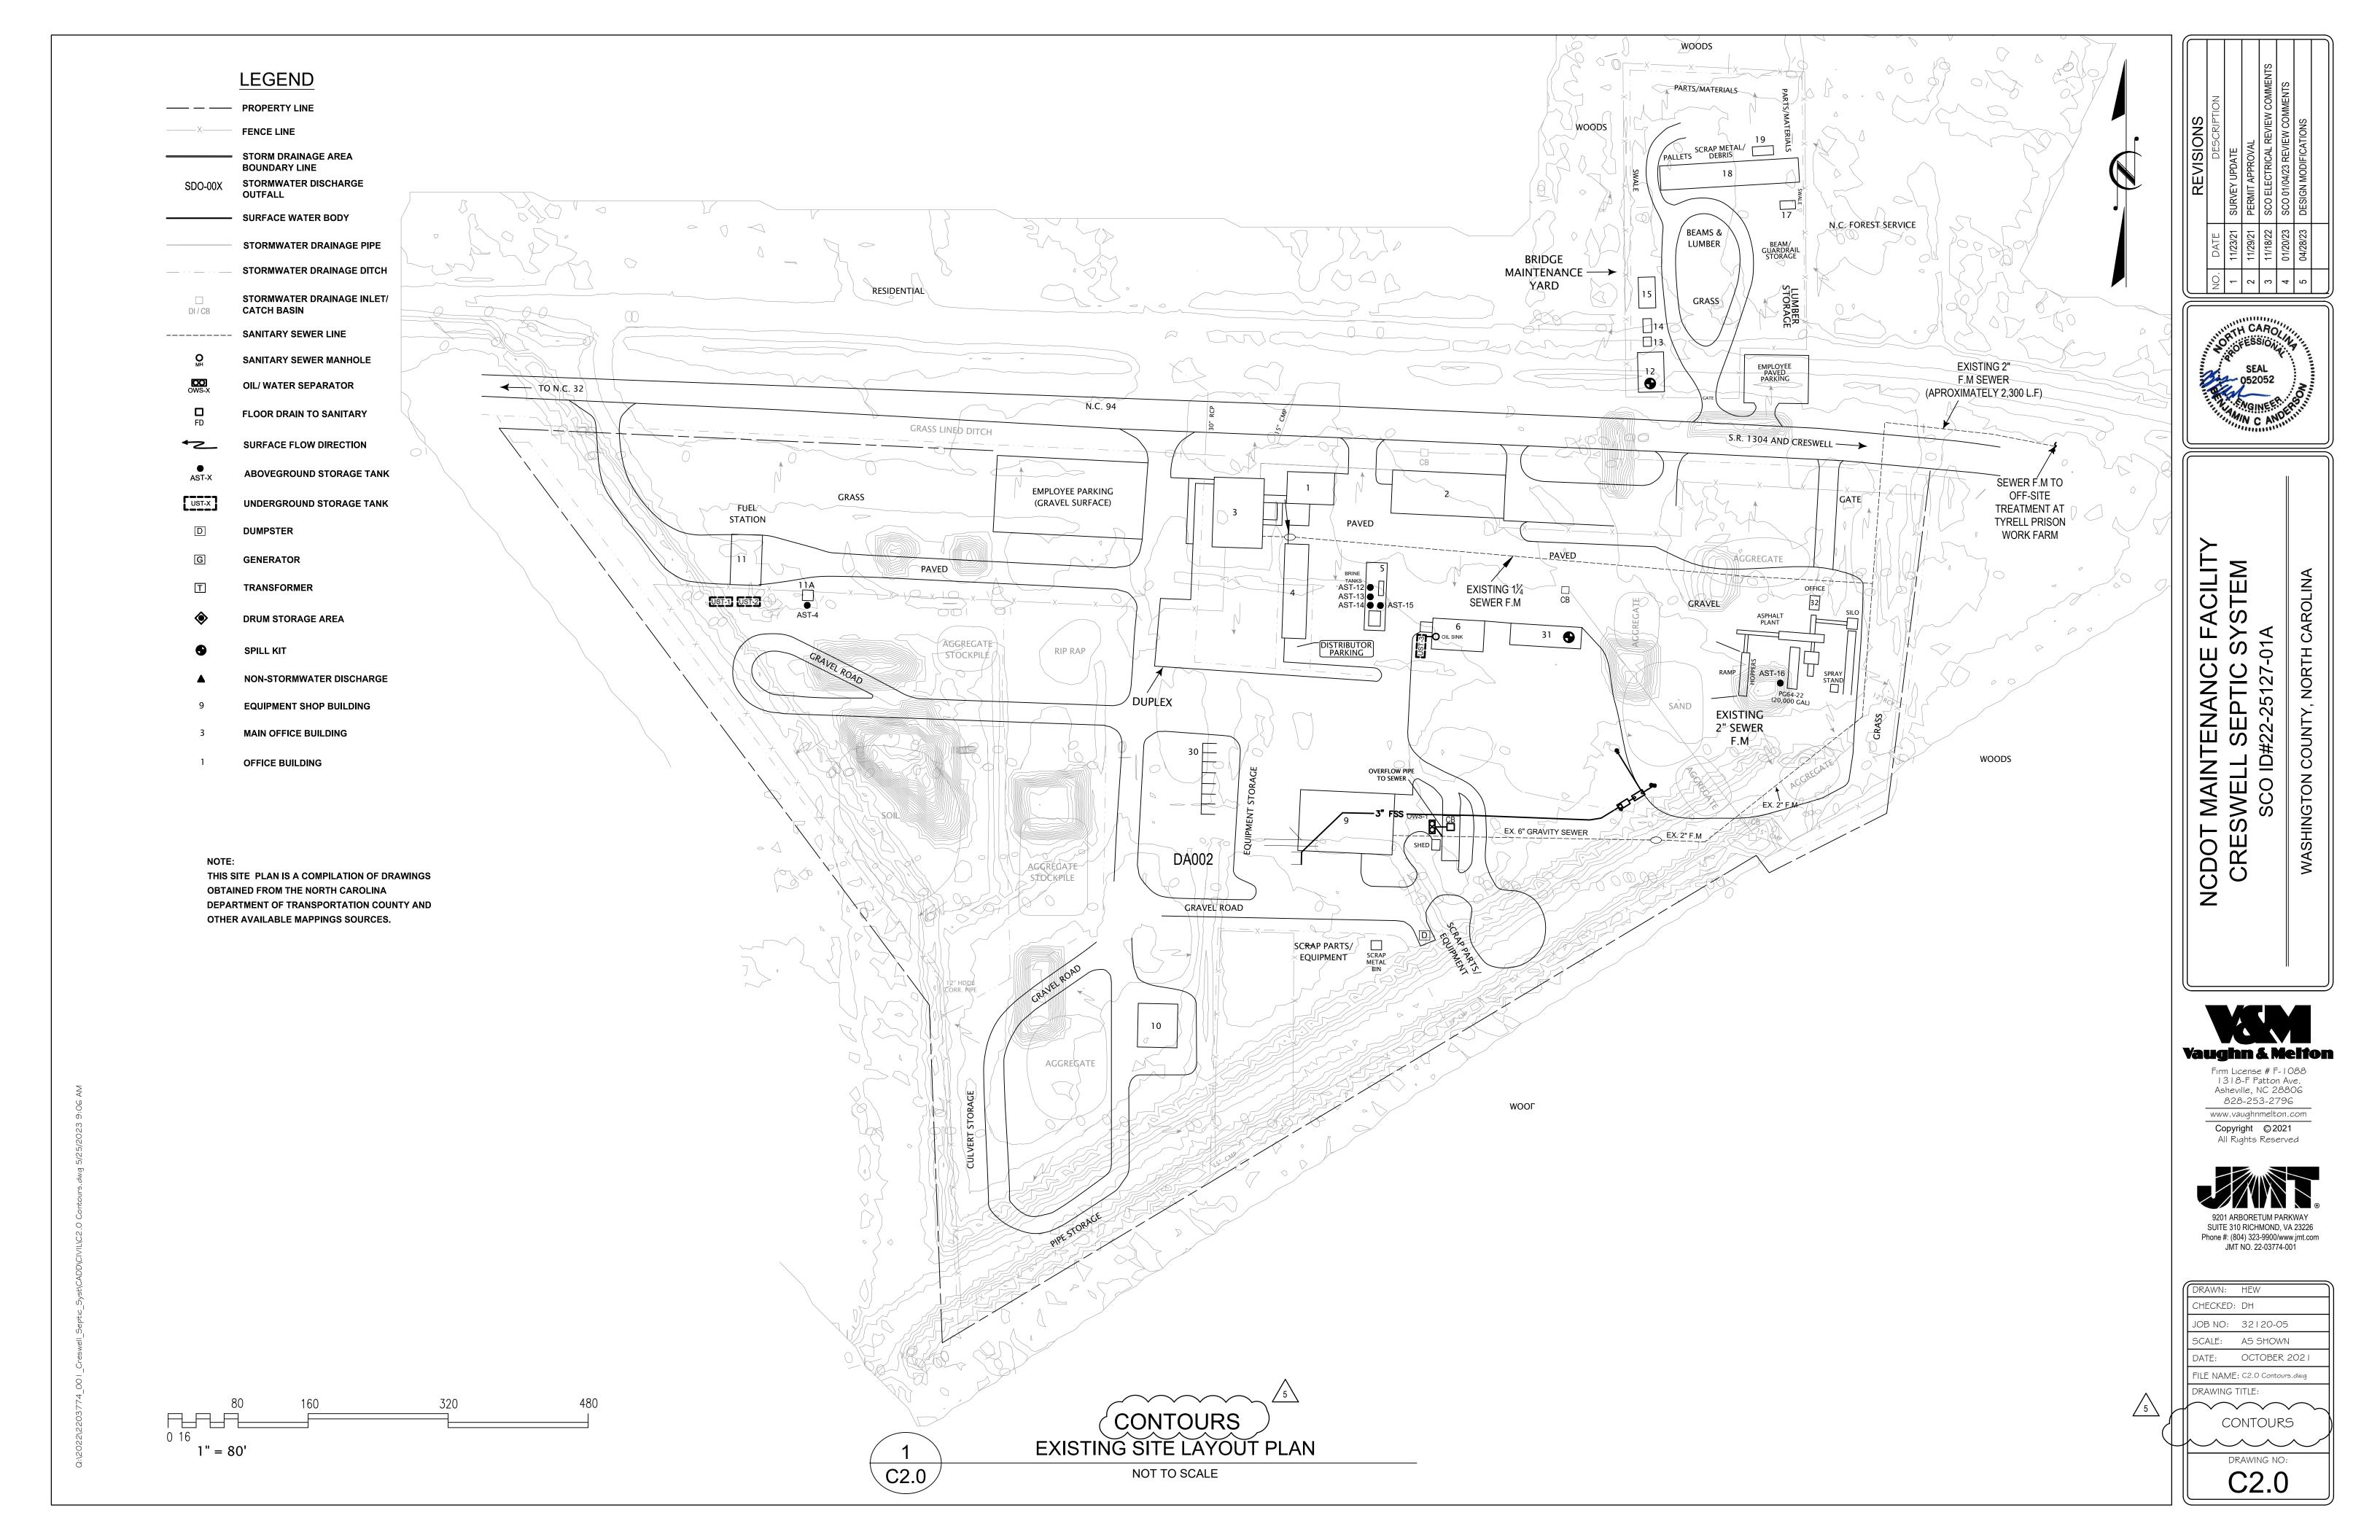

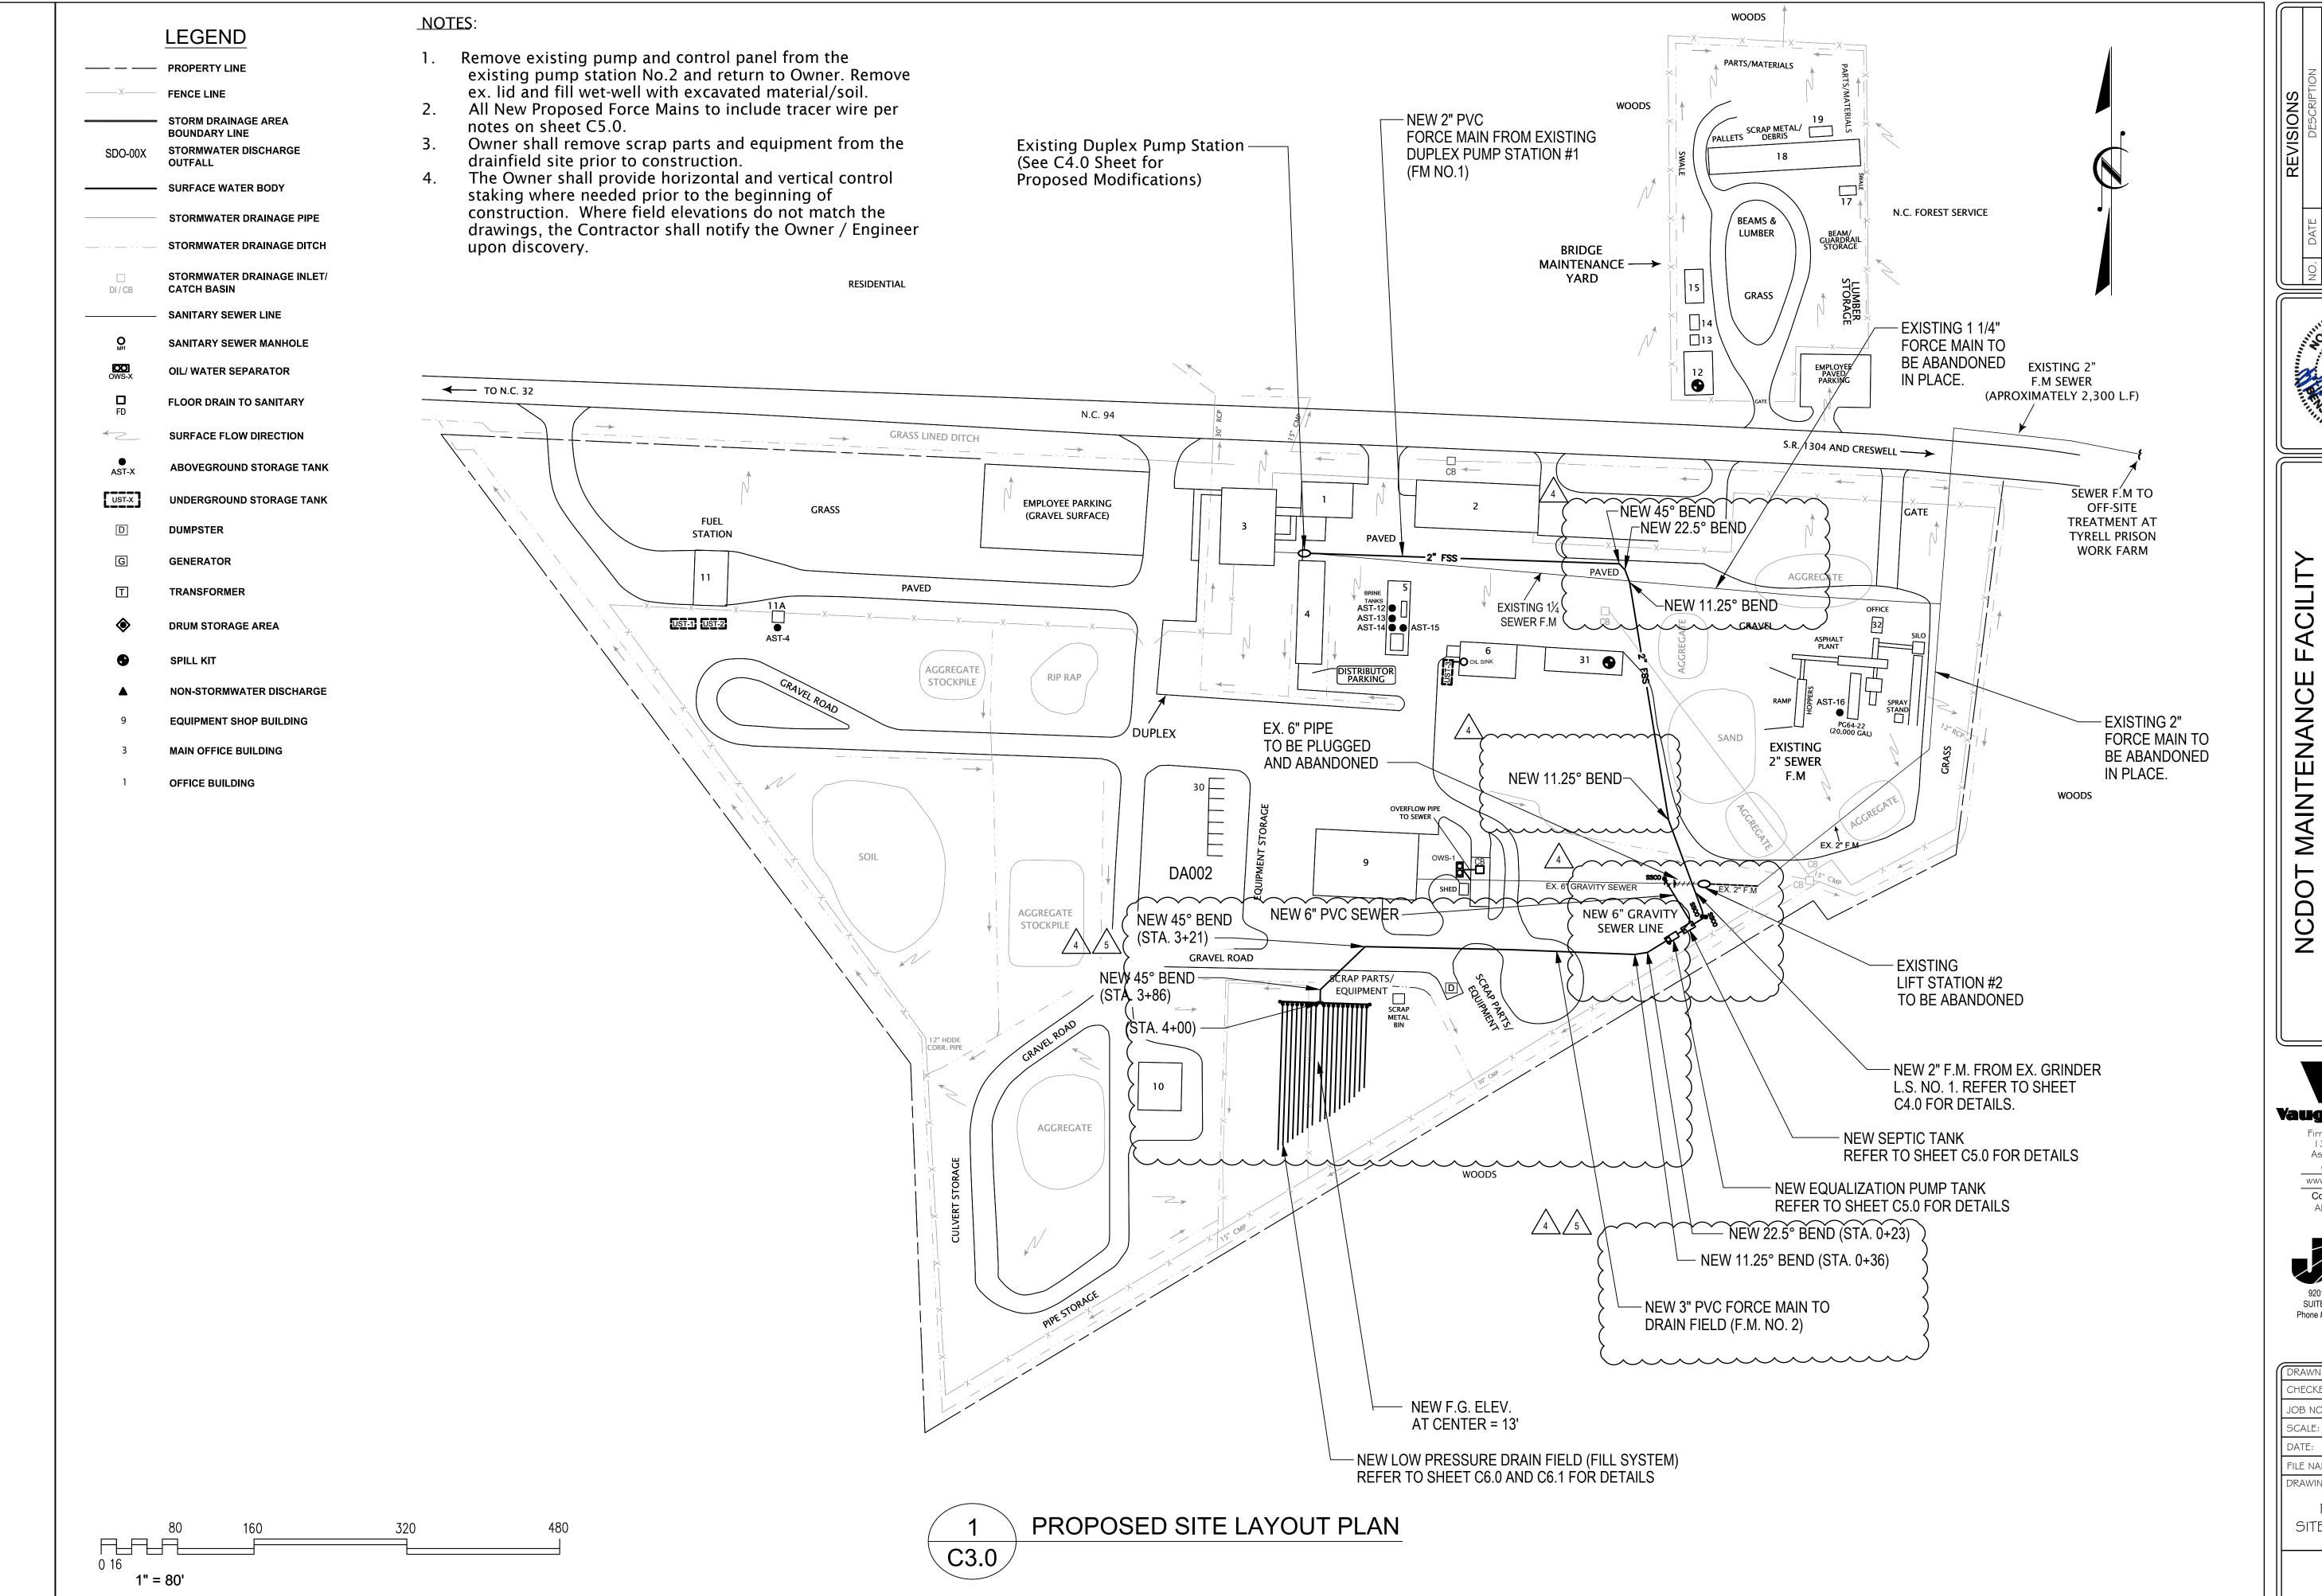

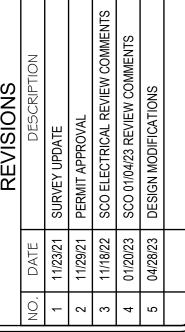NCDOT MAINTENANCE FACILIT CRESWELL SEPTIC SYSTEM SCO ID#22-25127-01A





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	CHECKED:	DH
	JOB NO:	32120-05
	SCALE:	AS SHOWN
	DATE:	OCTOBER 202
	FILE NAME:	- C3.0 Proposed Site : Plan.dwg
	DRAWING T	TITLE:
		OPOSED AYOUT PLA

C3.0





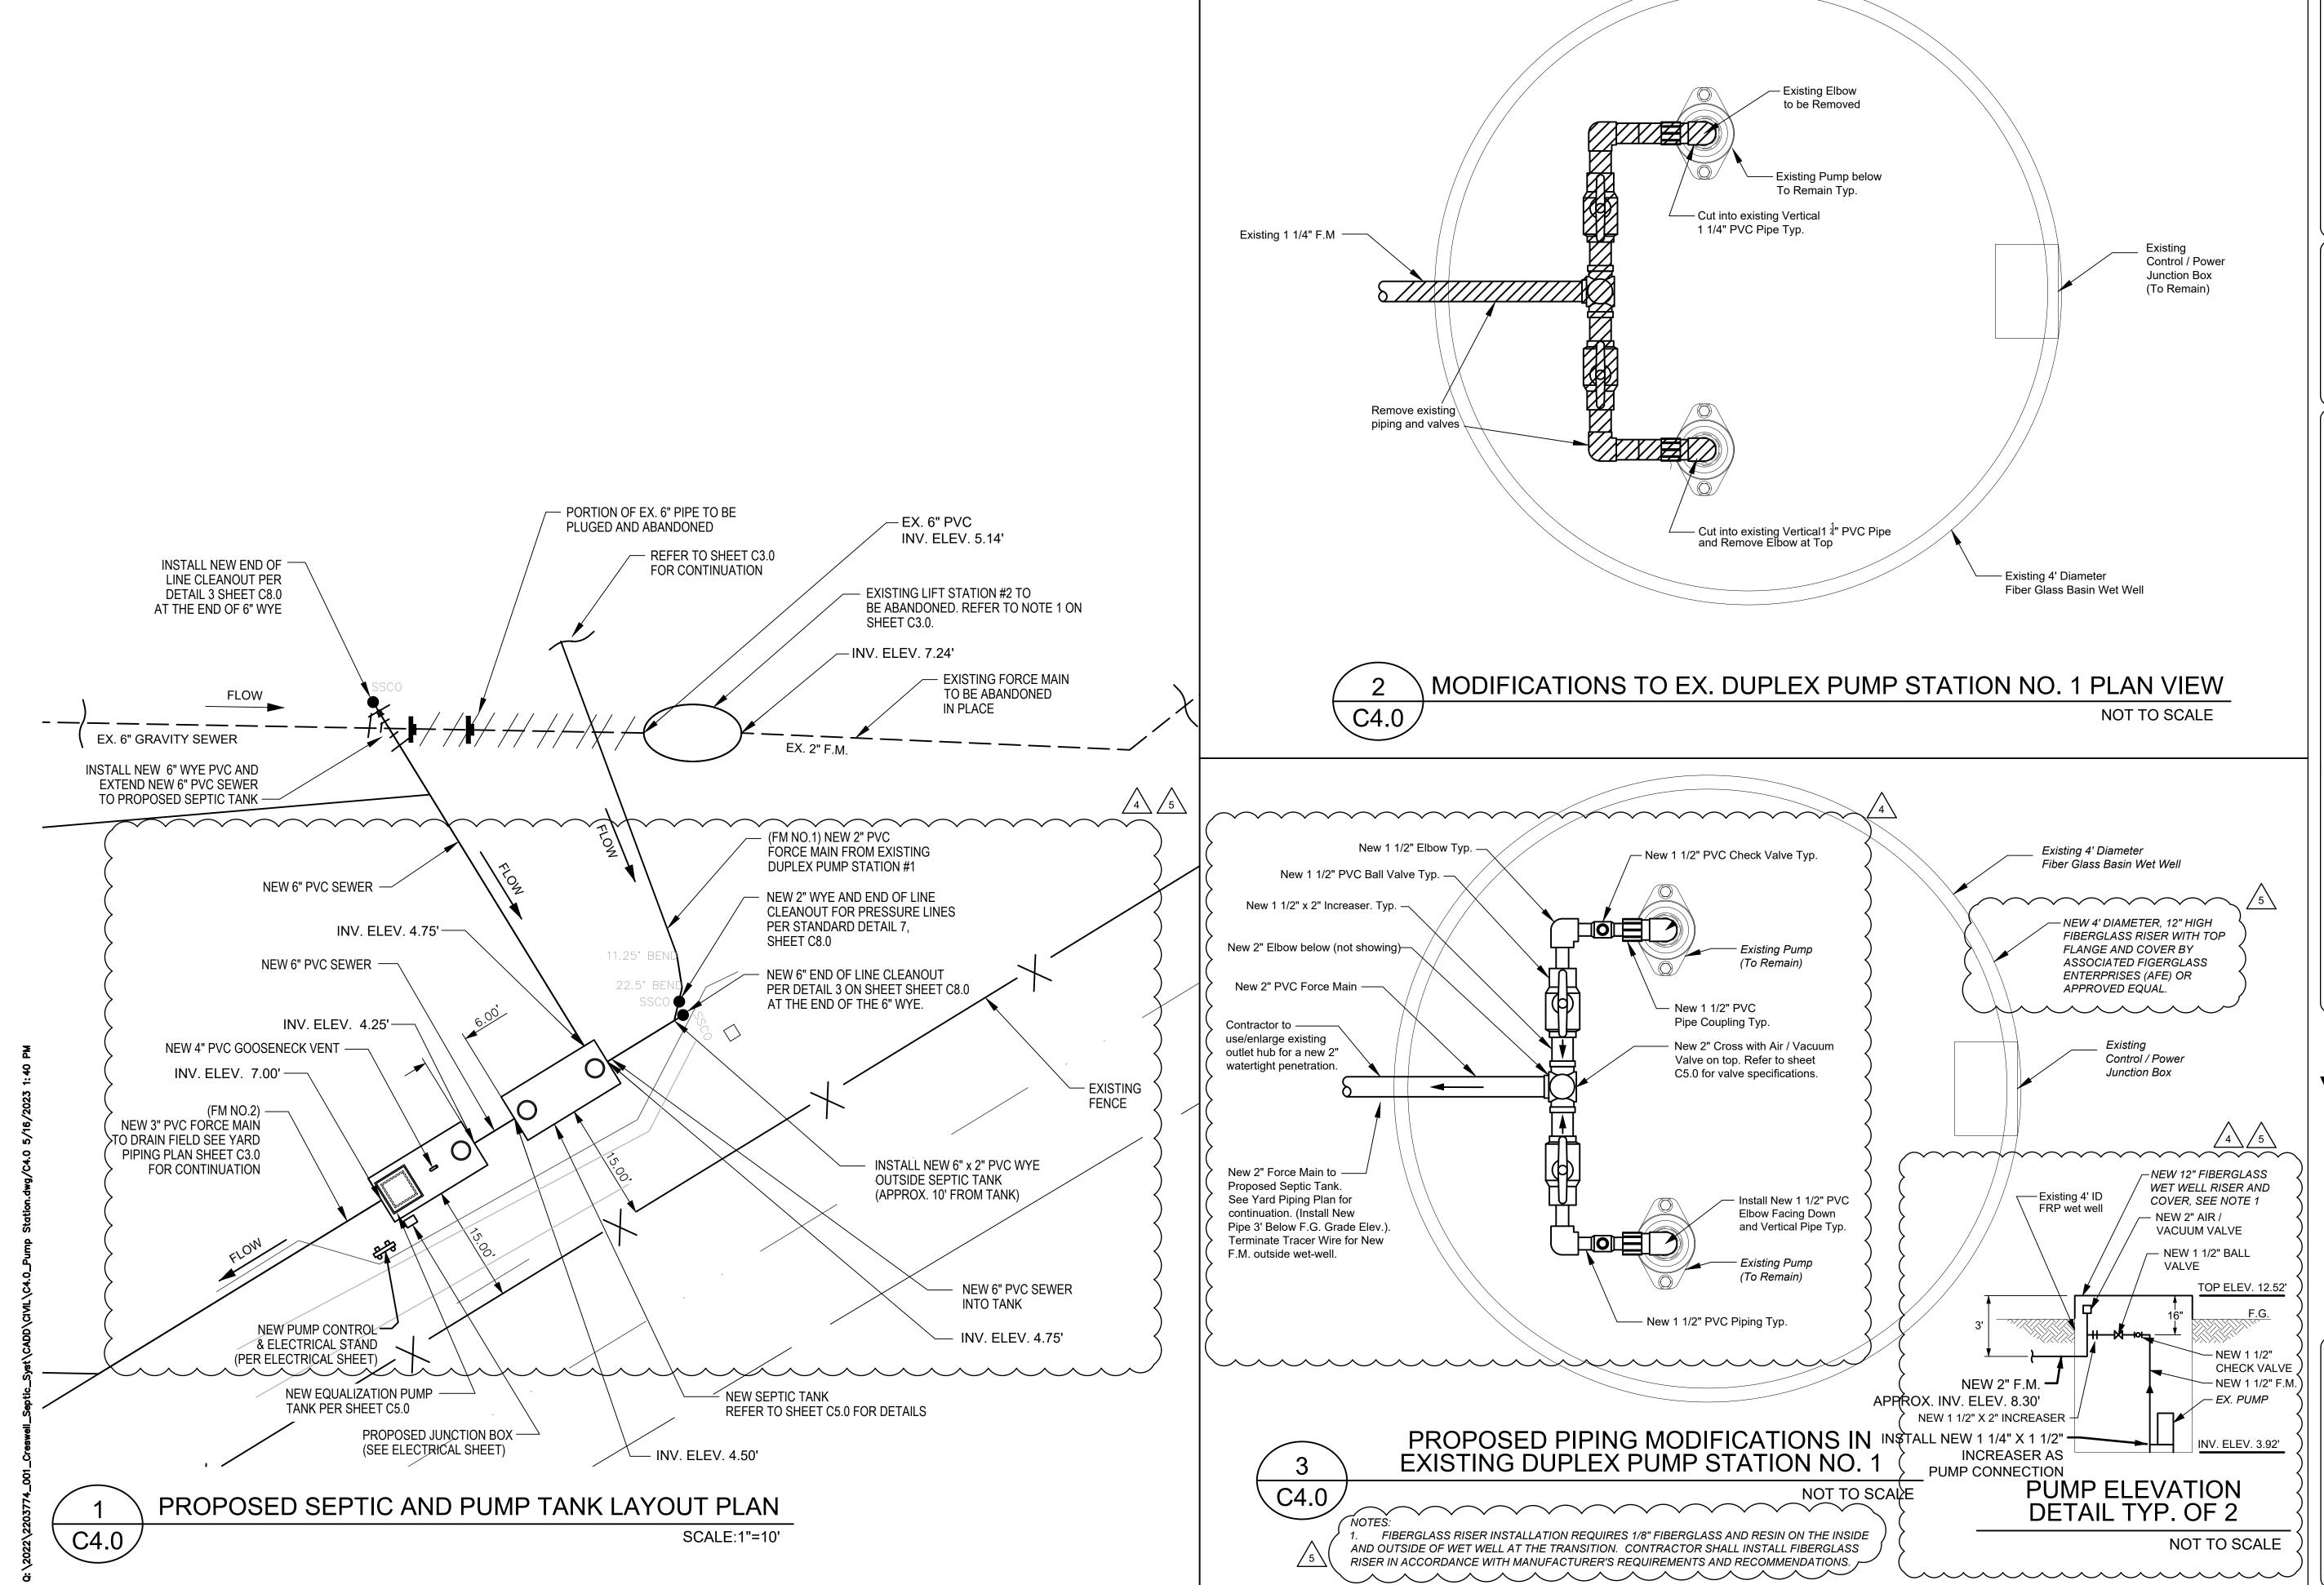

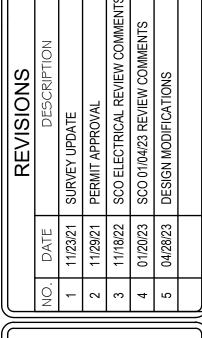NCDOT MAINTENANCE FACILITY
CRESWELL SEPTIC SYSTEM
SCO ID#22-25127-01A

NORTH CAROLINA

COUNTY,

WASHINGTON

Vaughn & Melton
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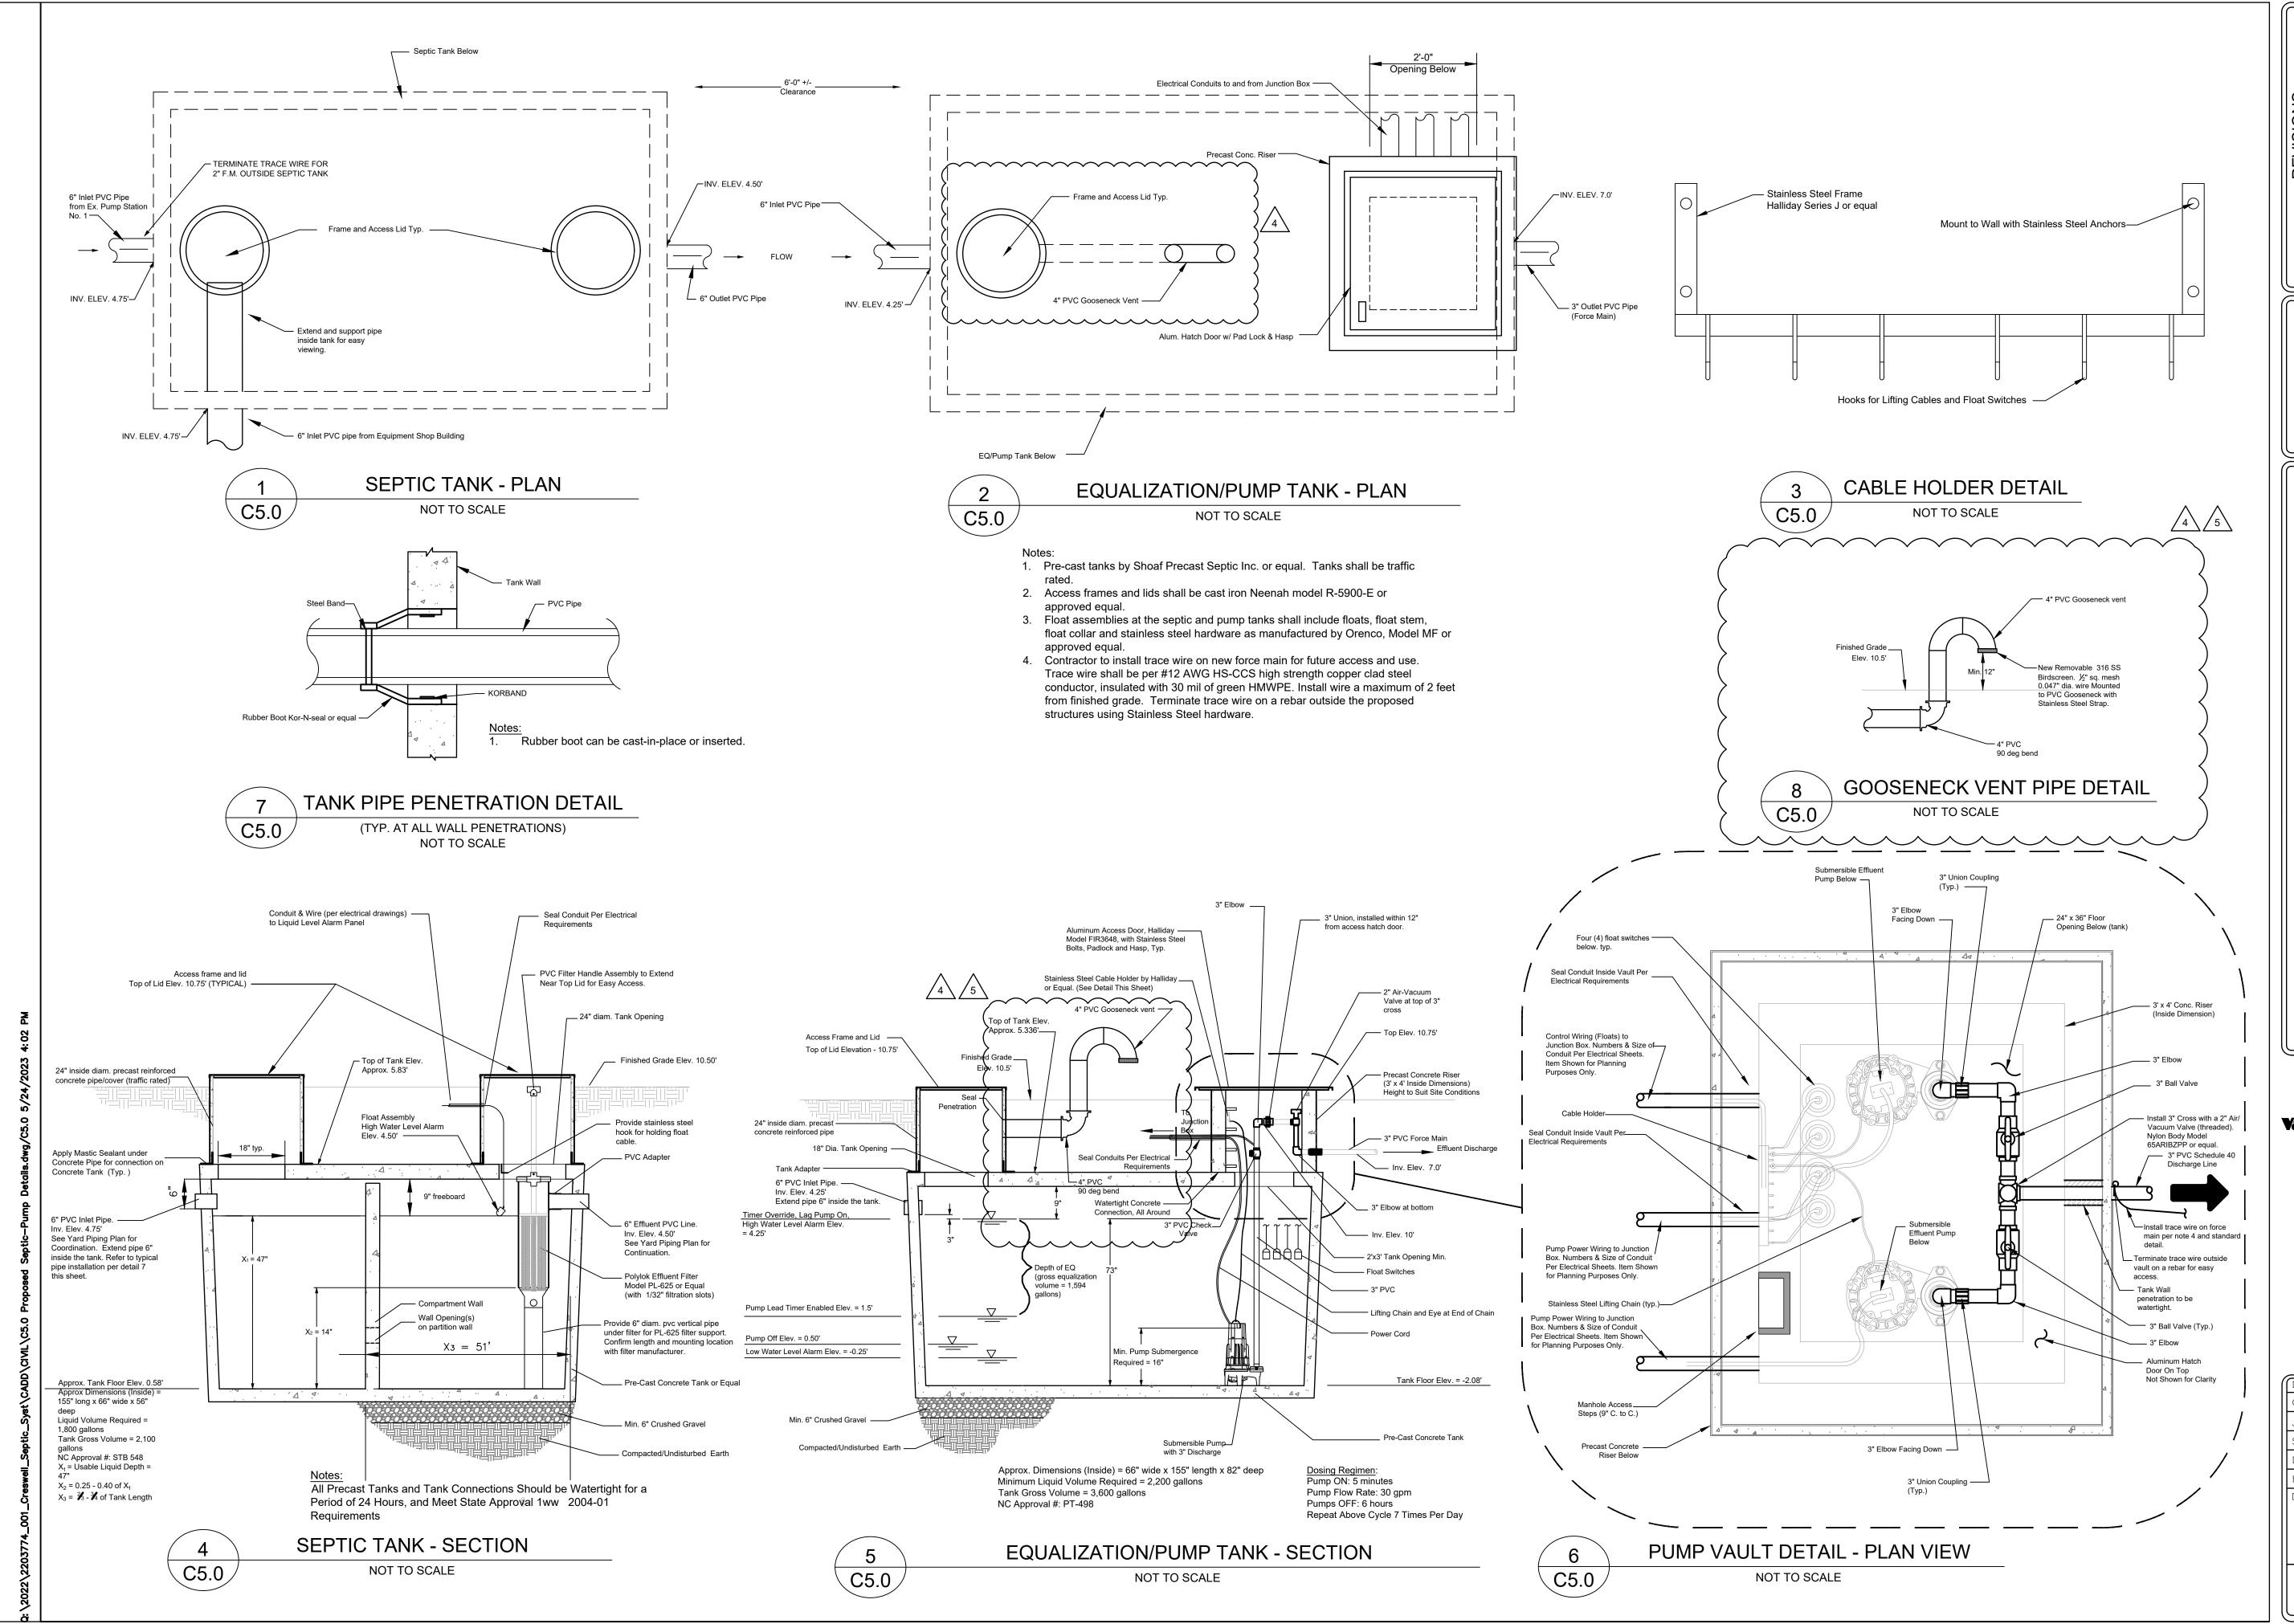
9201 ARBORETUM PARKWAY SUITE 310 RICHMOND, VA 23226 Phone #: (804) 323-9900/www.jmt.com JMT NO. 22-03774-001


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SCALE:	AS SHOWN
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FILE NAME	: C4.0_Pump Station.dwg
DRAWING 1	TITLE:
PROPO	OSED SEPTIC

AND PUMP TANK
LAYOUT PLAN

DRAWING NO:

C4.0



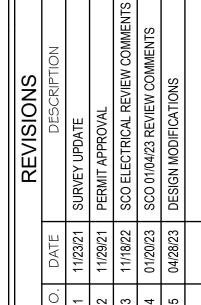



NCDOT MAINTENANCE FACILITY CRESWELL SEPTIC SYSTEM SCO ID#22-25127-01A

Vaughn & Melto


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DRAWN:	HEW
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JOB NO:	32120-05
SCALE:	AS SHOWN
DATE:	OCTOBER 2021
FILE NAME:	C5.0 Proposed Septic-Pur : Details.dwg
DRAWING T	TITLE:
PROPO	OSED SEPTIC
AND 1	PUMP TANK

DRAWING NO:

DETAILS




DRAINFIELD (FILL SYSTEM) **CROSS SECTION VIEW** C6.1 SCALE: 1" = 6'

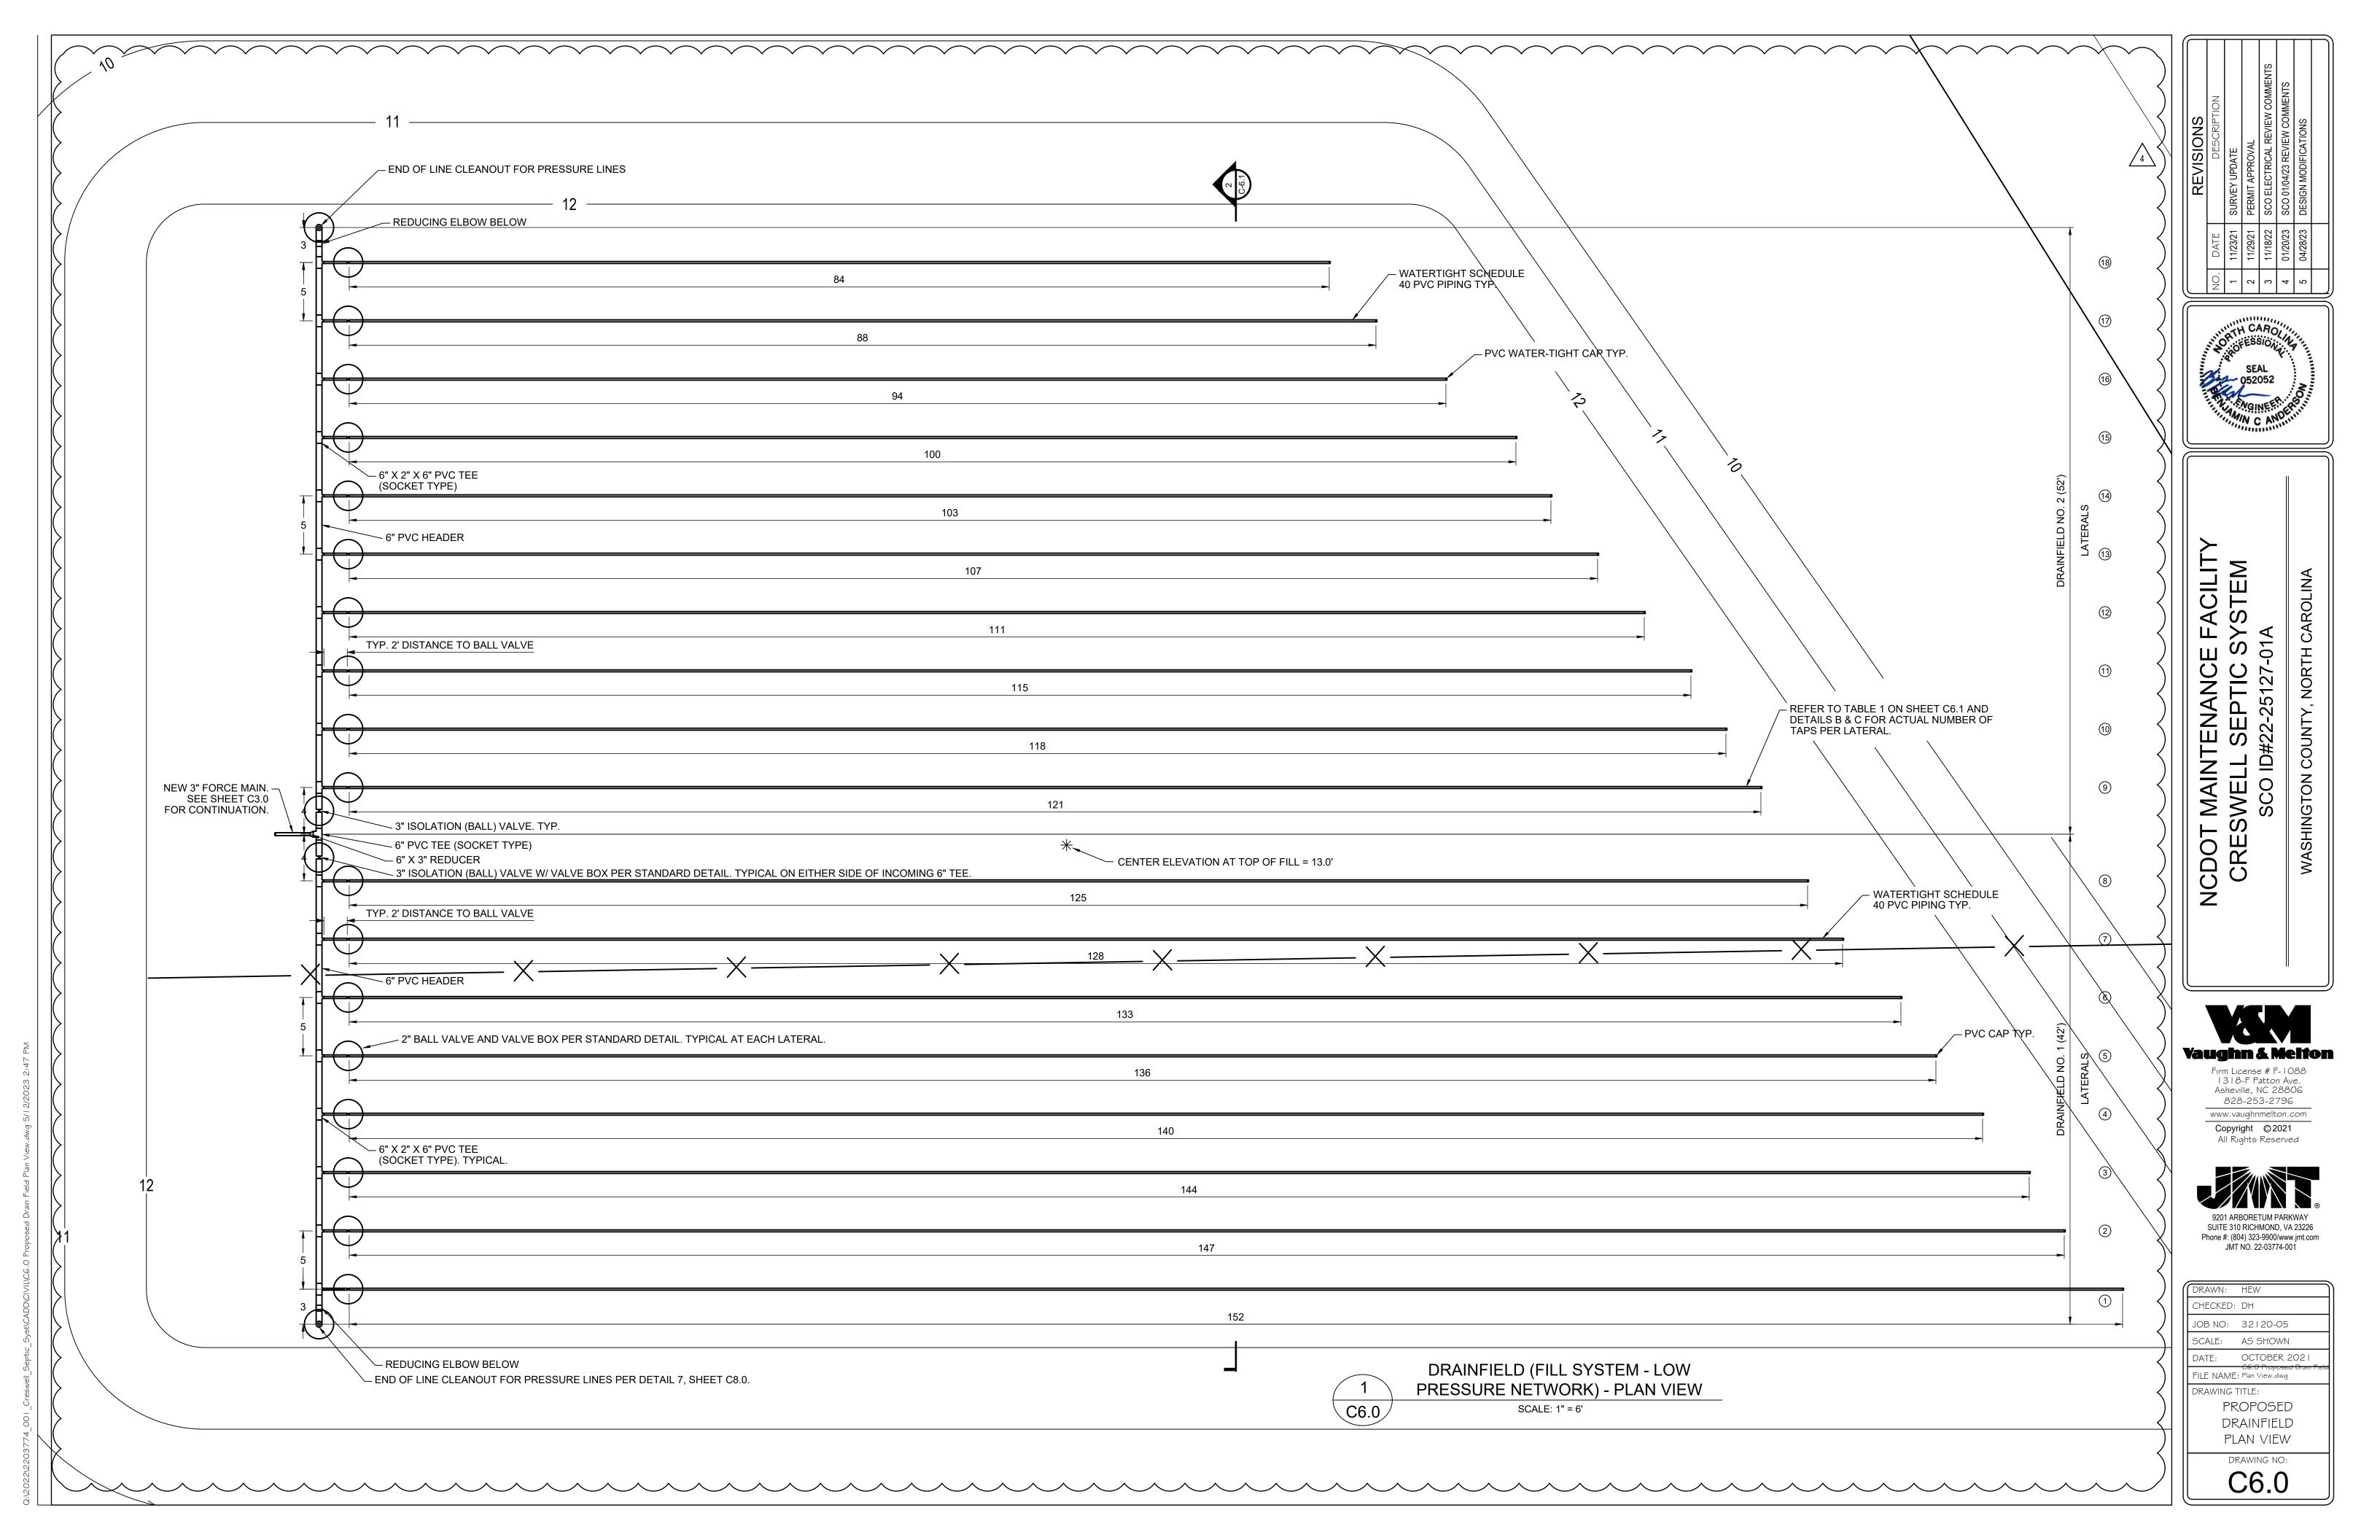
OPERATIONAL NOTES:

- 1. ONE DRAIN FIELD WILL BE OPERATED AT A TIME.
 THE OTHER DRAIN FIELD WILL BE PLACED OFF-LINE
 BY CLOSING THE ISOLATION VALVE NEXT TO THE 6" TEE AT THE MANIFOLD.
- 2. SYSTEM OPERATOR WILL ALTERNATE USE OF THE DRAIN FIELDS APPROXIMATELY EVERY SIX MONTHS.
- 3. BALL VALVE AT THE BEGINNING OF EACH LATERAL SHALL BE USED TO ADJUST FLOW / HEAD TO EACH LATERAL DURING SYSTEM INSTALLATION / INSPECTION.
 DO NOT COVER DRAINFIELD PIPING UNTIL SYSTEM IS
 INSPECTED AND APPROVED BY LHD.


		TABLE 1 - TAP S	SPACING AND FLO	W INFORMATION PI	ER DRAINFIELD	
	ASSUME TAP D	IAMETER = 3/16	FLOW PER TA	AP = 0.646 gpm	ASSUME TAP SPACING, FT = 10	
	FIELD LINE	LENGTH OF LATERAL	DISTANCE TO FIRST TAP	NUMBER OF TAPS PER LATERAL	FLOW PER LATERAL	
	1	152	2	15	9.69	
_	2	147	2	14	9.044	
NO.	3	144	2	14	9.044	
ا م	4	140	2	13	8.398	
ORAINFIELD	5	136	2	13	8.1396	
N N	6	133	2	13	9.398	
RA	7	128	2	12	7.6228	TOTAL FLOW =
	8	125	2	12	7.429	68.7654
	9	121	2	11	7.106	
	10	118	2	11	6.9768	
). 2	11	115	2	11	6.783	
NO.	12	111	2	10	6.5246	
I	13	107	2	10	6.2662	
ORAINFIELD	14	103	2	10	6.46	
A A	15	100	2	9	5.814	
DR.	16	94	2	9	5.814	
	17	88	2	8	5.0388	TOTAL FLOW =
	18	84	2	8	5.168	61.9514

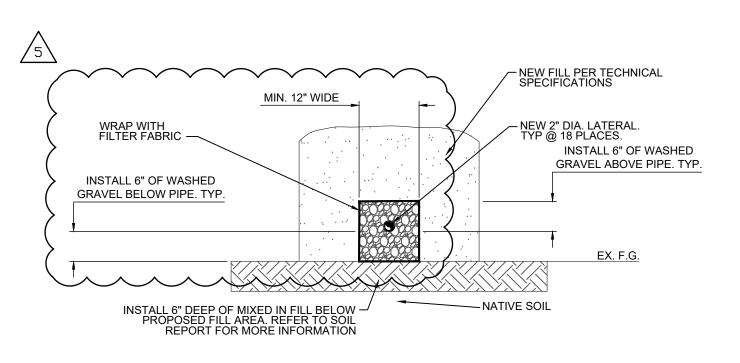

DETAIL "A" - LATERAL TRENCH TYP. C6.1 NOT TO SCALE

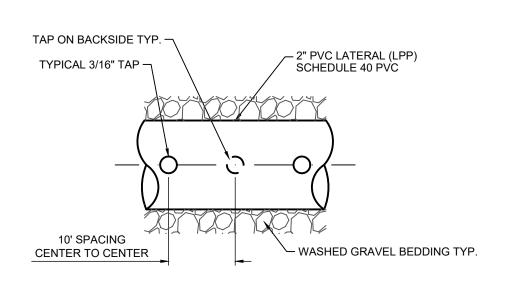

DETAIL "B" - LATERAL TAPS - ELEVATION C6.1 NOT TO SCALE

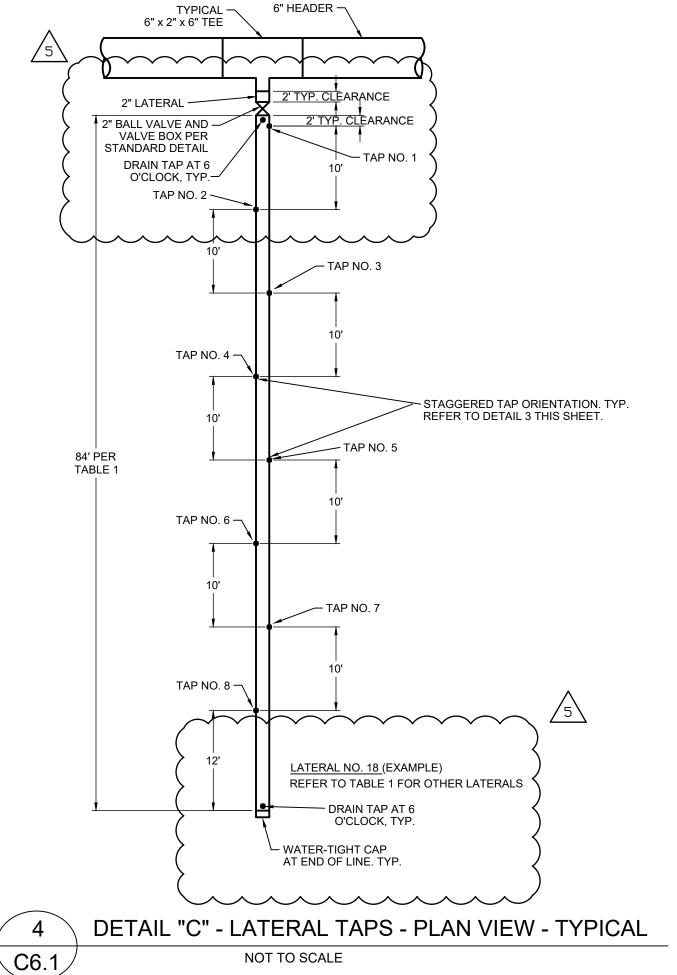

• FILL MATERIAL TO BE FREE OF VEGETATIVE COVER OR ORGANIC LITTER.

NOT TO SCALE

REVISIONS	DESCRIPTION	SURVEY UPDATE	PERMIT APPROVAL	SCO ELECTRICAL REVIEW COMMENTS	SCO 01/04/23 REVIEW COMMENTS	DESIGN MODIFICATIONS	
	DATE	11/23/21	11/29/21	11/18/22	01/20/23	04/28/23	
	NO.	1	2	3	4	2	



\Box


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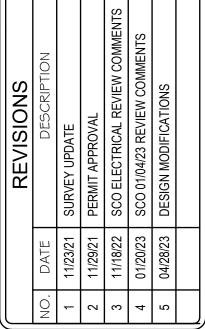


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(DRAWN:	HEW	
$\ [$	CHECKED:	DH	
	JOB NO:	32120-05	
	SCALE:	AS SHOWN	
	DATE:	OCTOBER 2021	
	C6.1 Proposed Drainfield FILE NAME: Section & Details.dwg		
ſ	DRAWING TITLE:		
l	PR	OPOSED	
	DR	AINFIELD	

DRAWING NO: C6.

SECTION & DETAILS



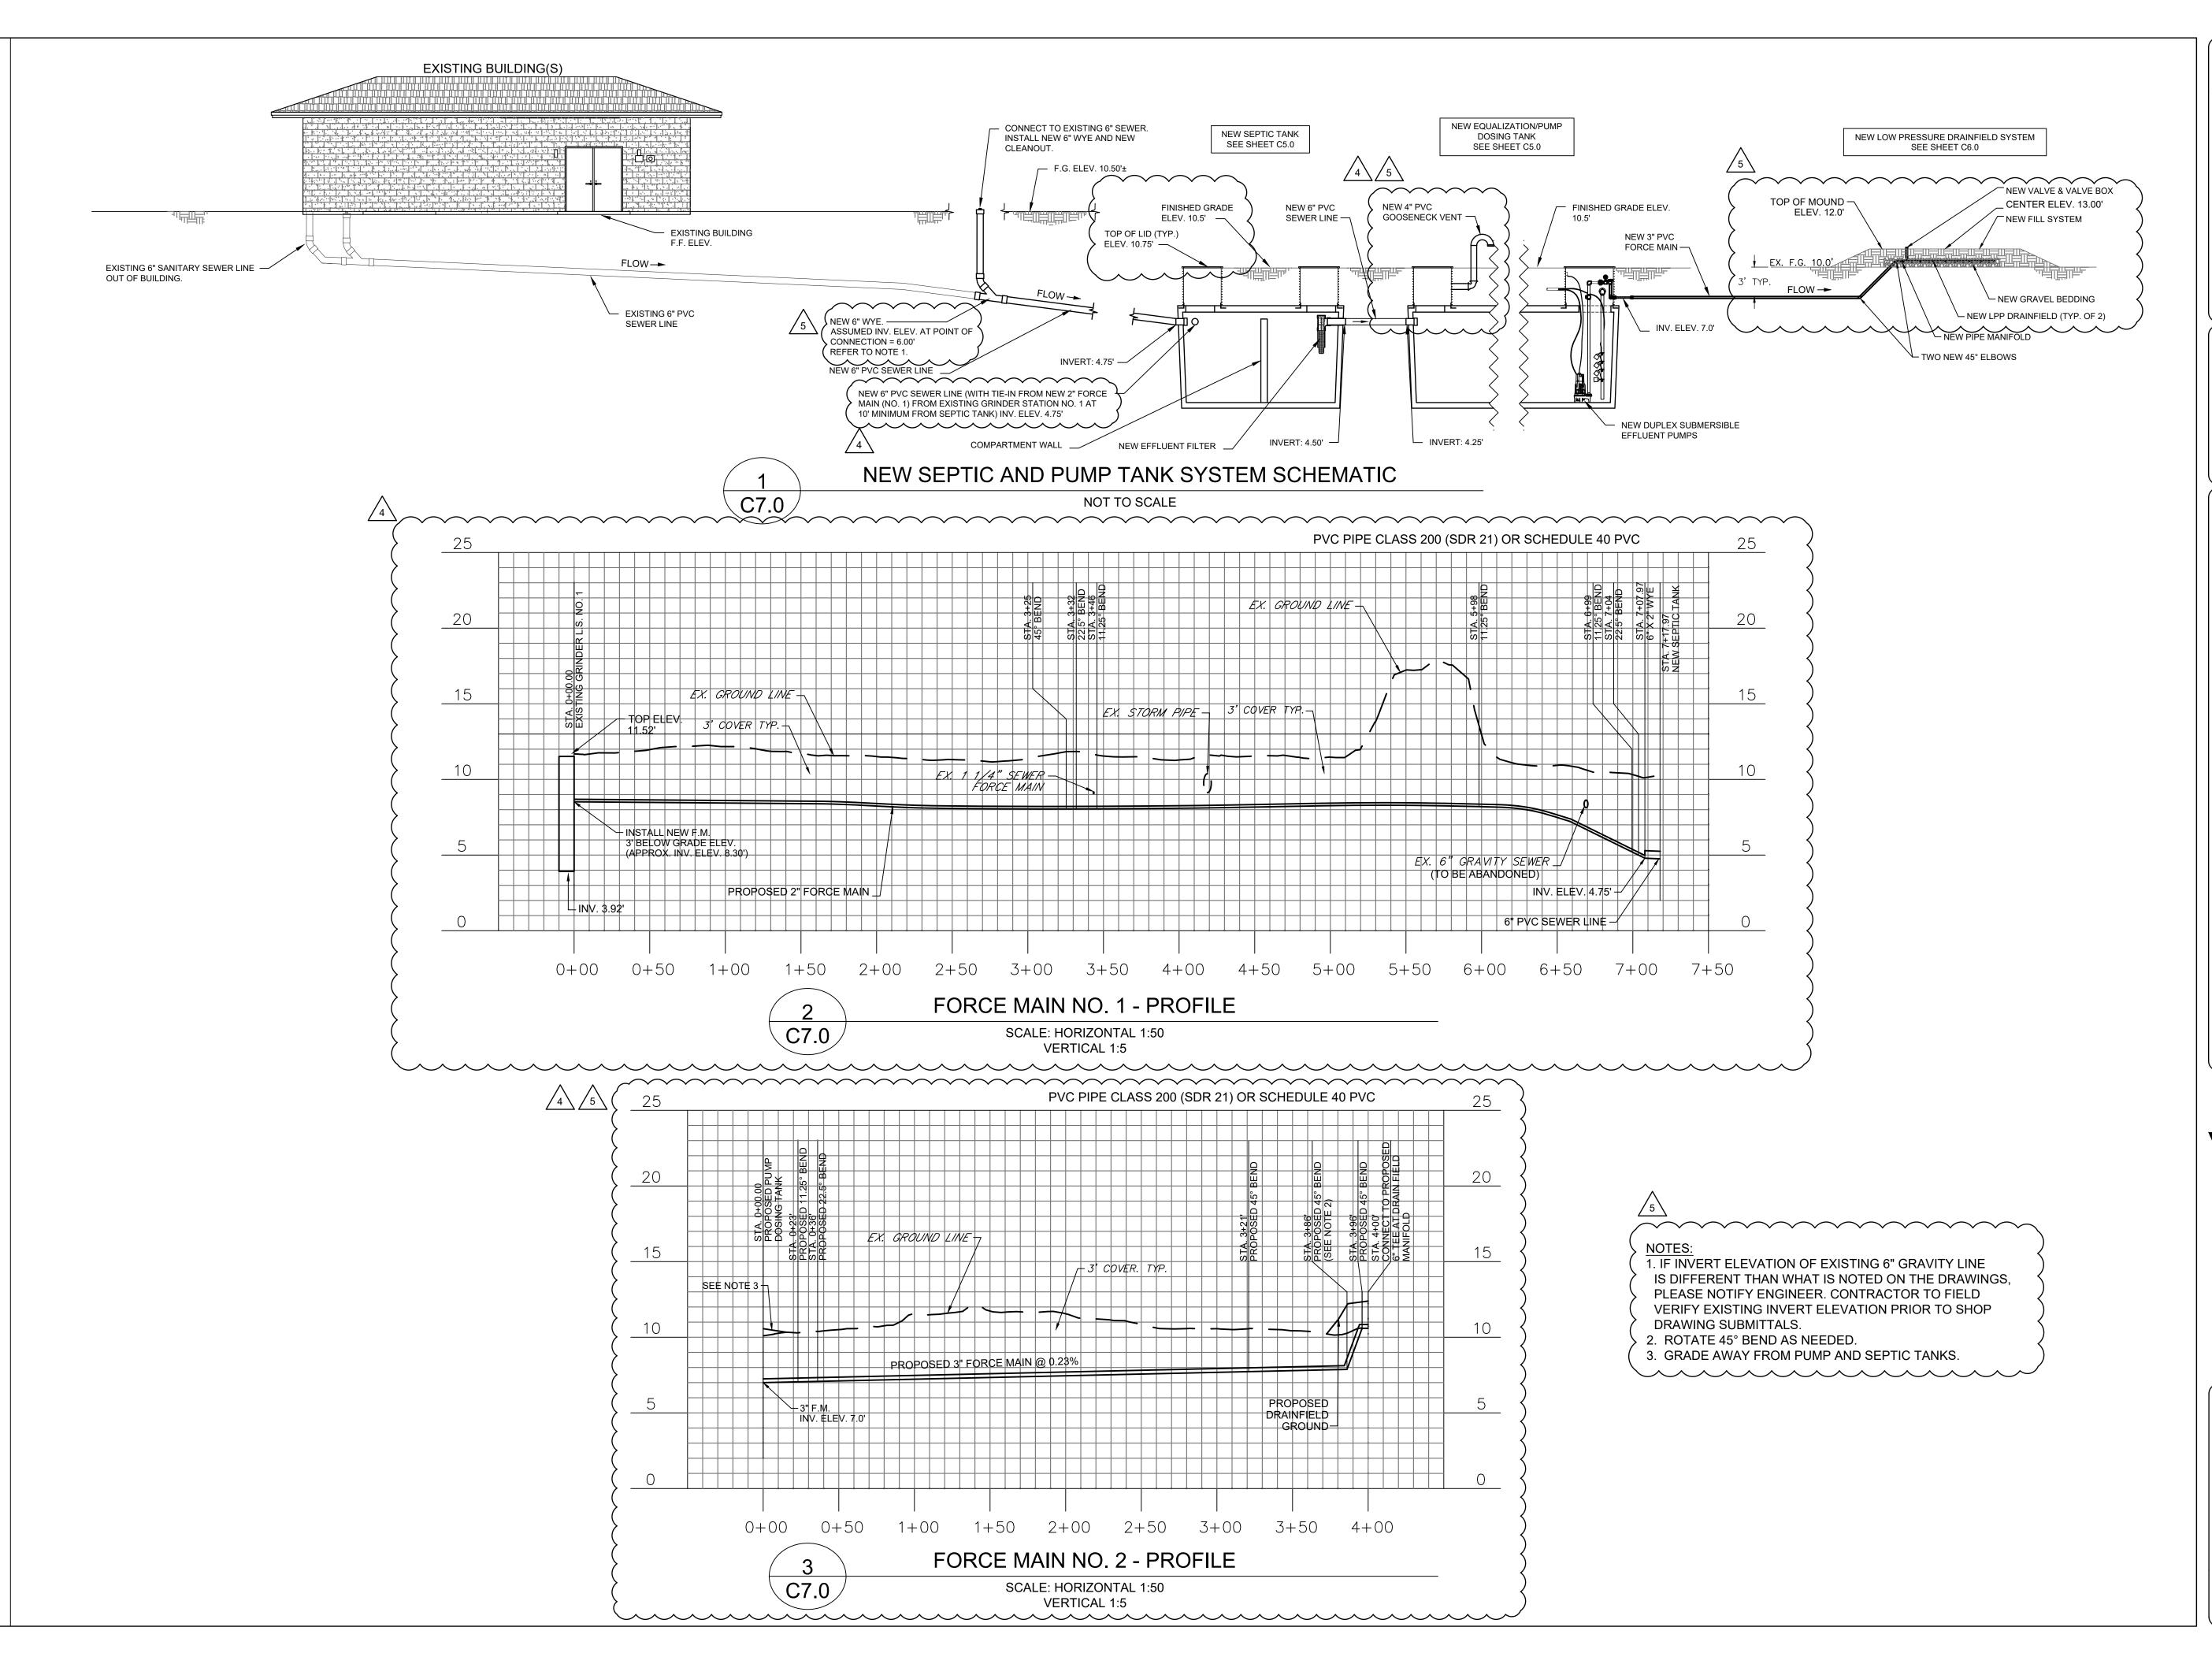



SCO ID#22-25127-01A




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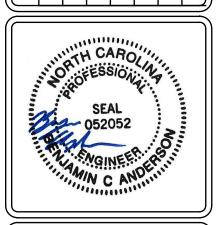


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JOB NO:	32120-05
SCALE:	AS SHOWN
DATE:	OCTOBER 2021
FILE NAME:	No.1 and No.2 Profiles.dw
DRAWING T	TITLE:
PROPO	OSED FORCE
MAIN I	NO.1 \$ NO.2
PF	ROFILES

C7 0



REVISIONS
3/21 DESCRIPTION
3/21 SURVEY UPDATE
9/21 PERMIT APPROVAL
8/22 SCO ELECTRICAL REVIEW COMMENTS
0/23 SCO 01/04/23 REVIEW COMMENTS
8/23 DESIGN MODIFICATIONS

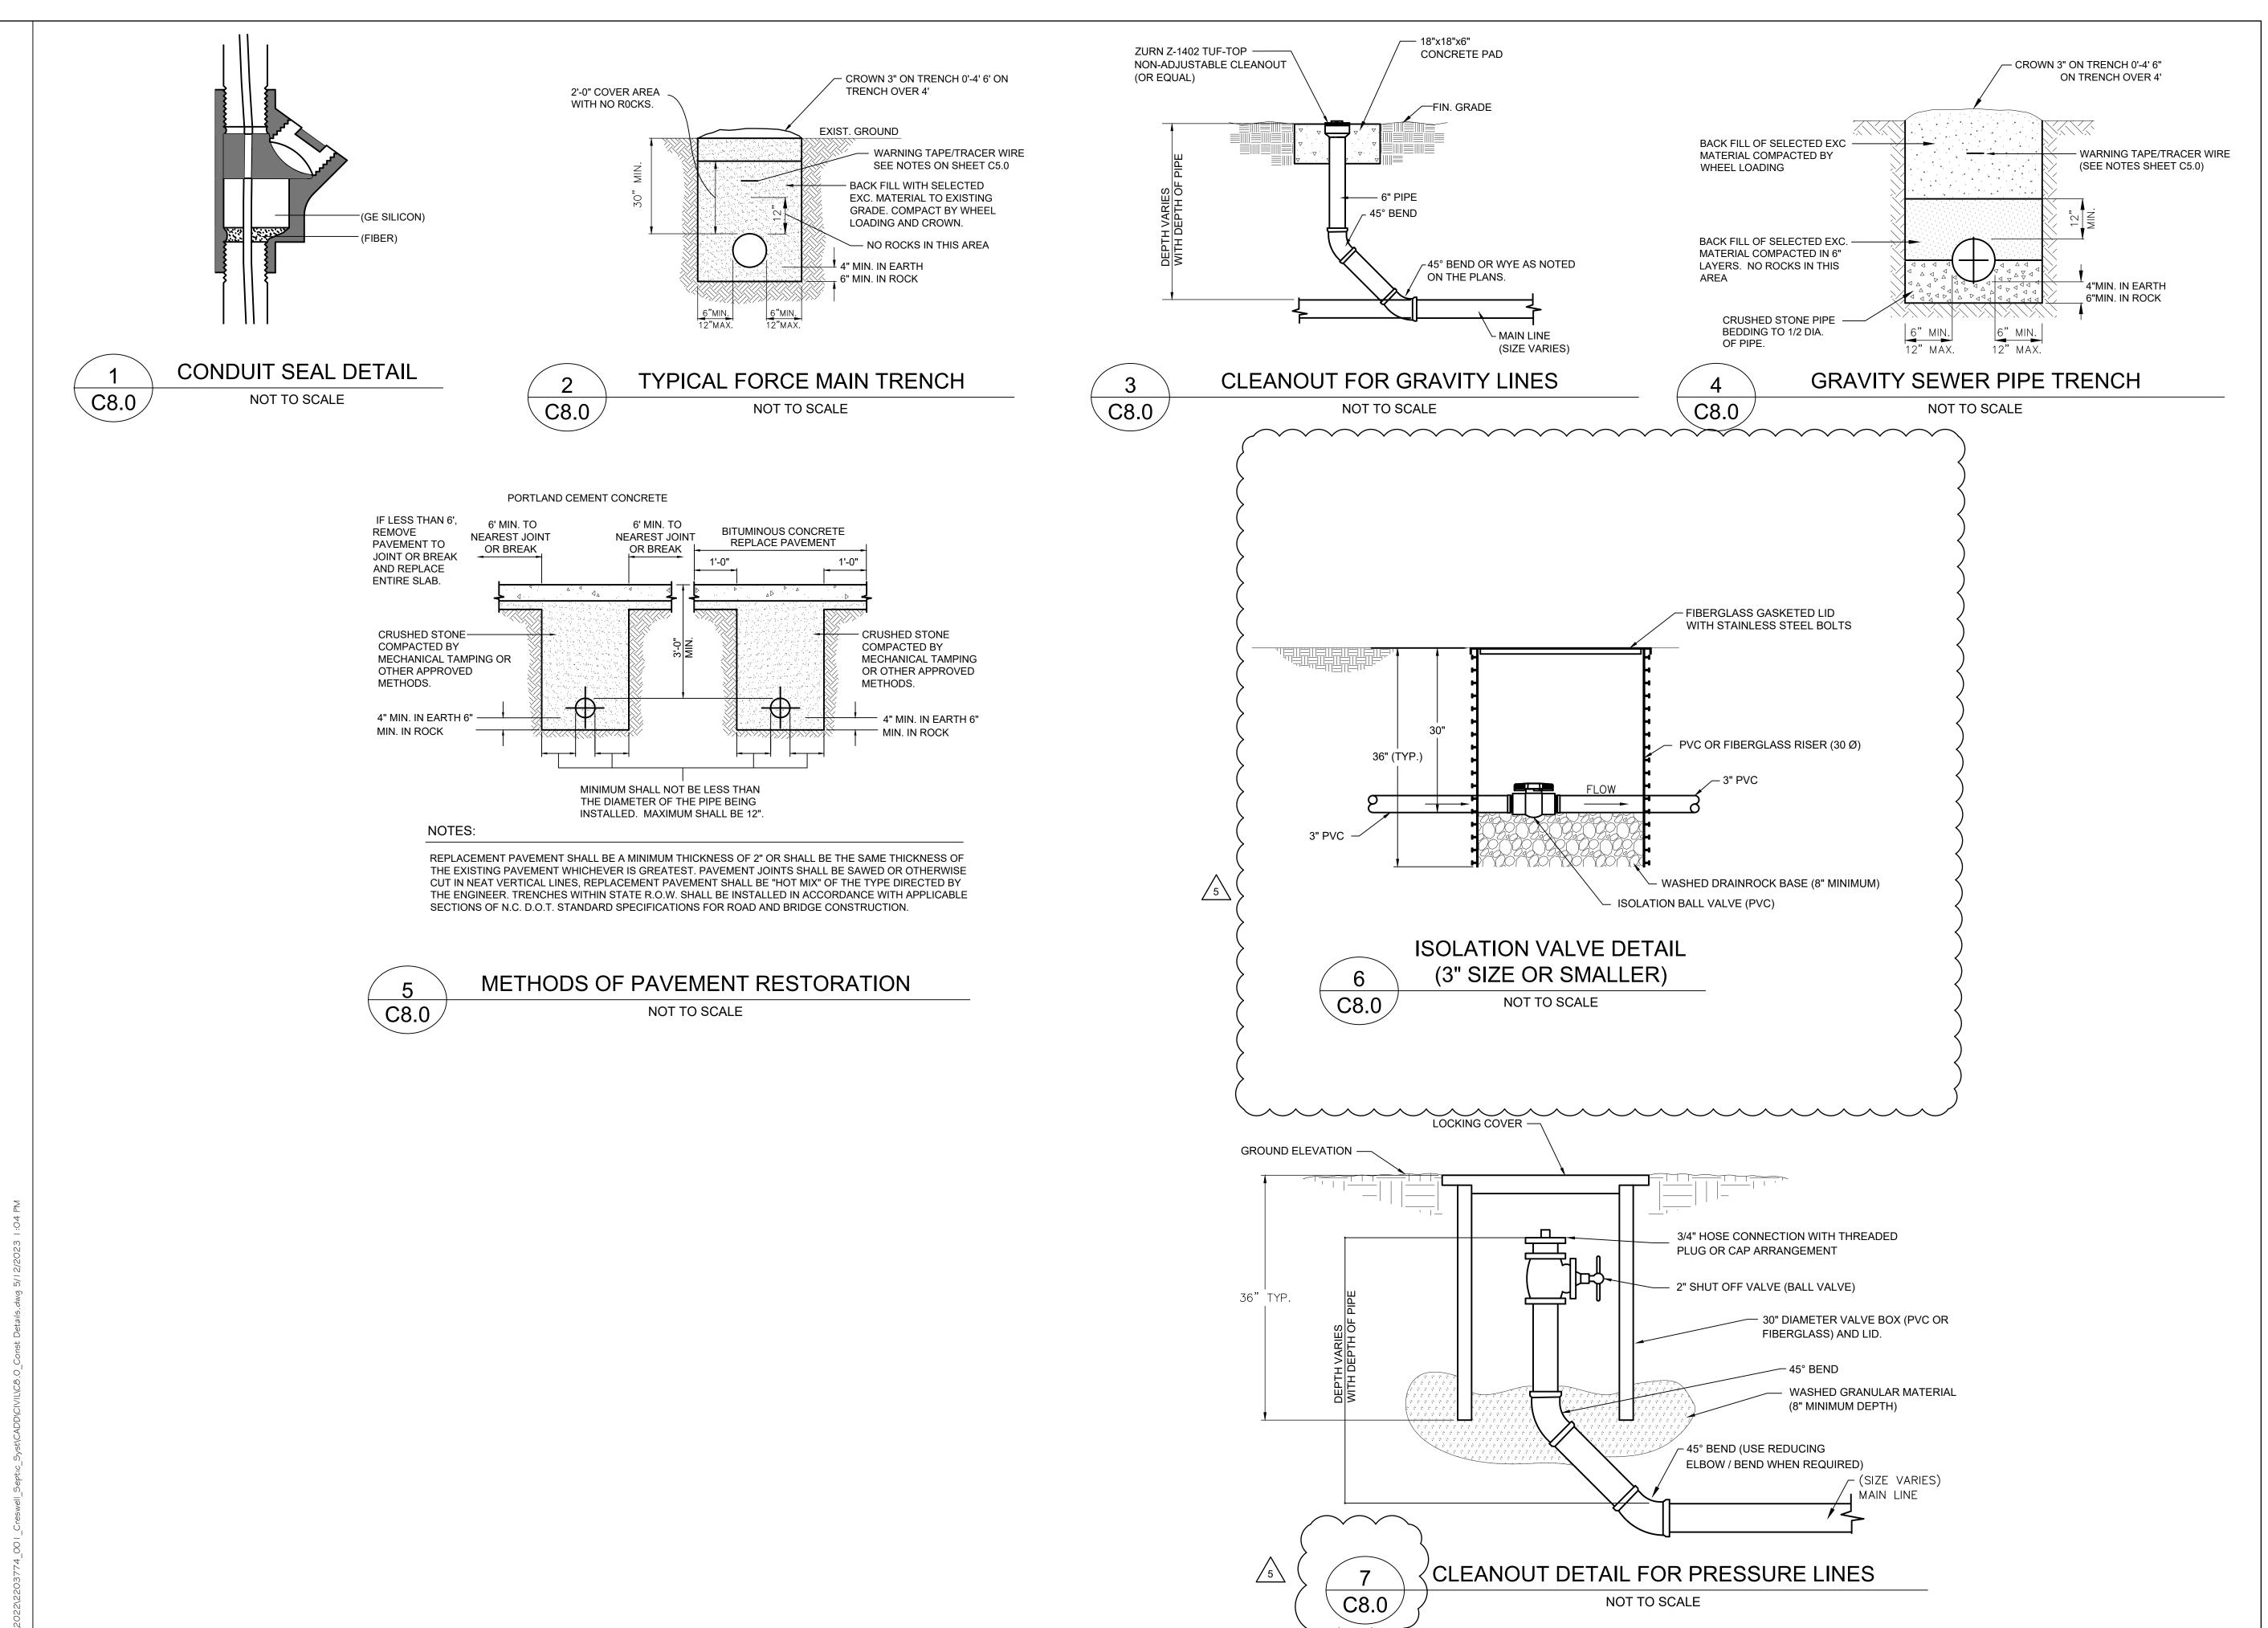

MAINTENANCE FACILITY SWELL SEPTIC SYSTEM SCO ID#22-25127-01A




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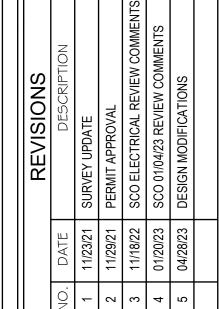
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SCALE:	AS SHOWN
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	STRUCTION DETAILS

DRAWING NO:





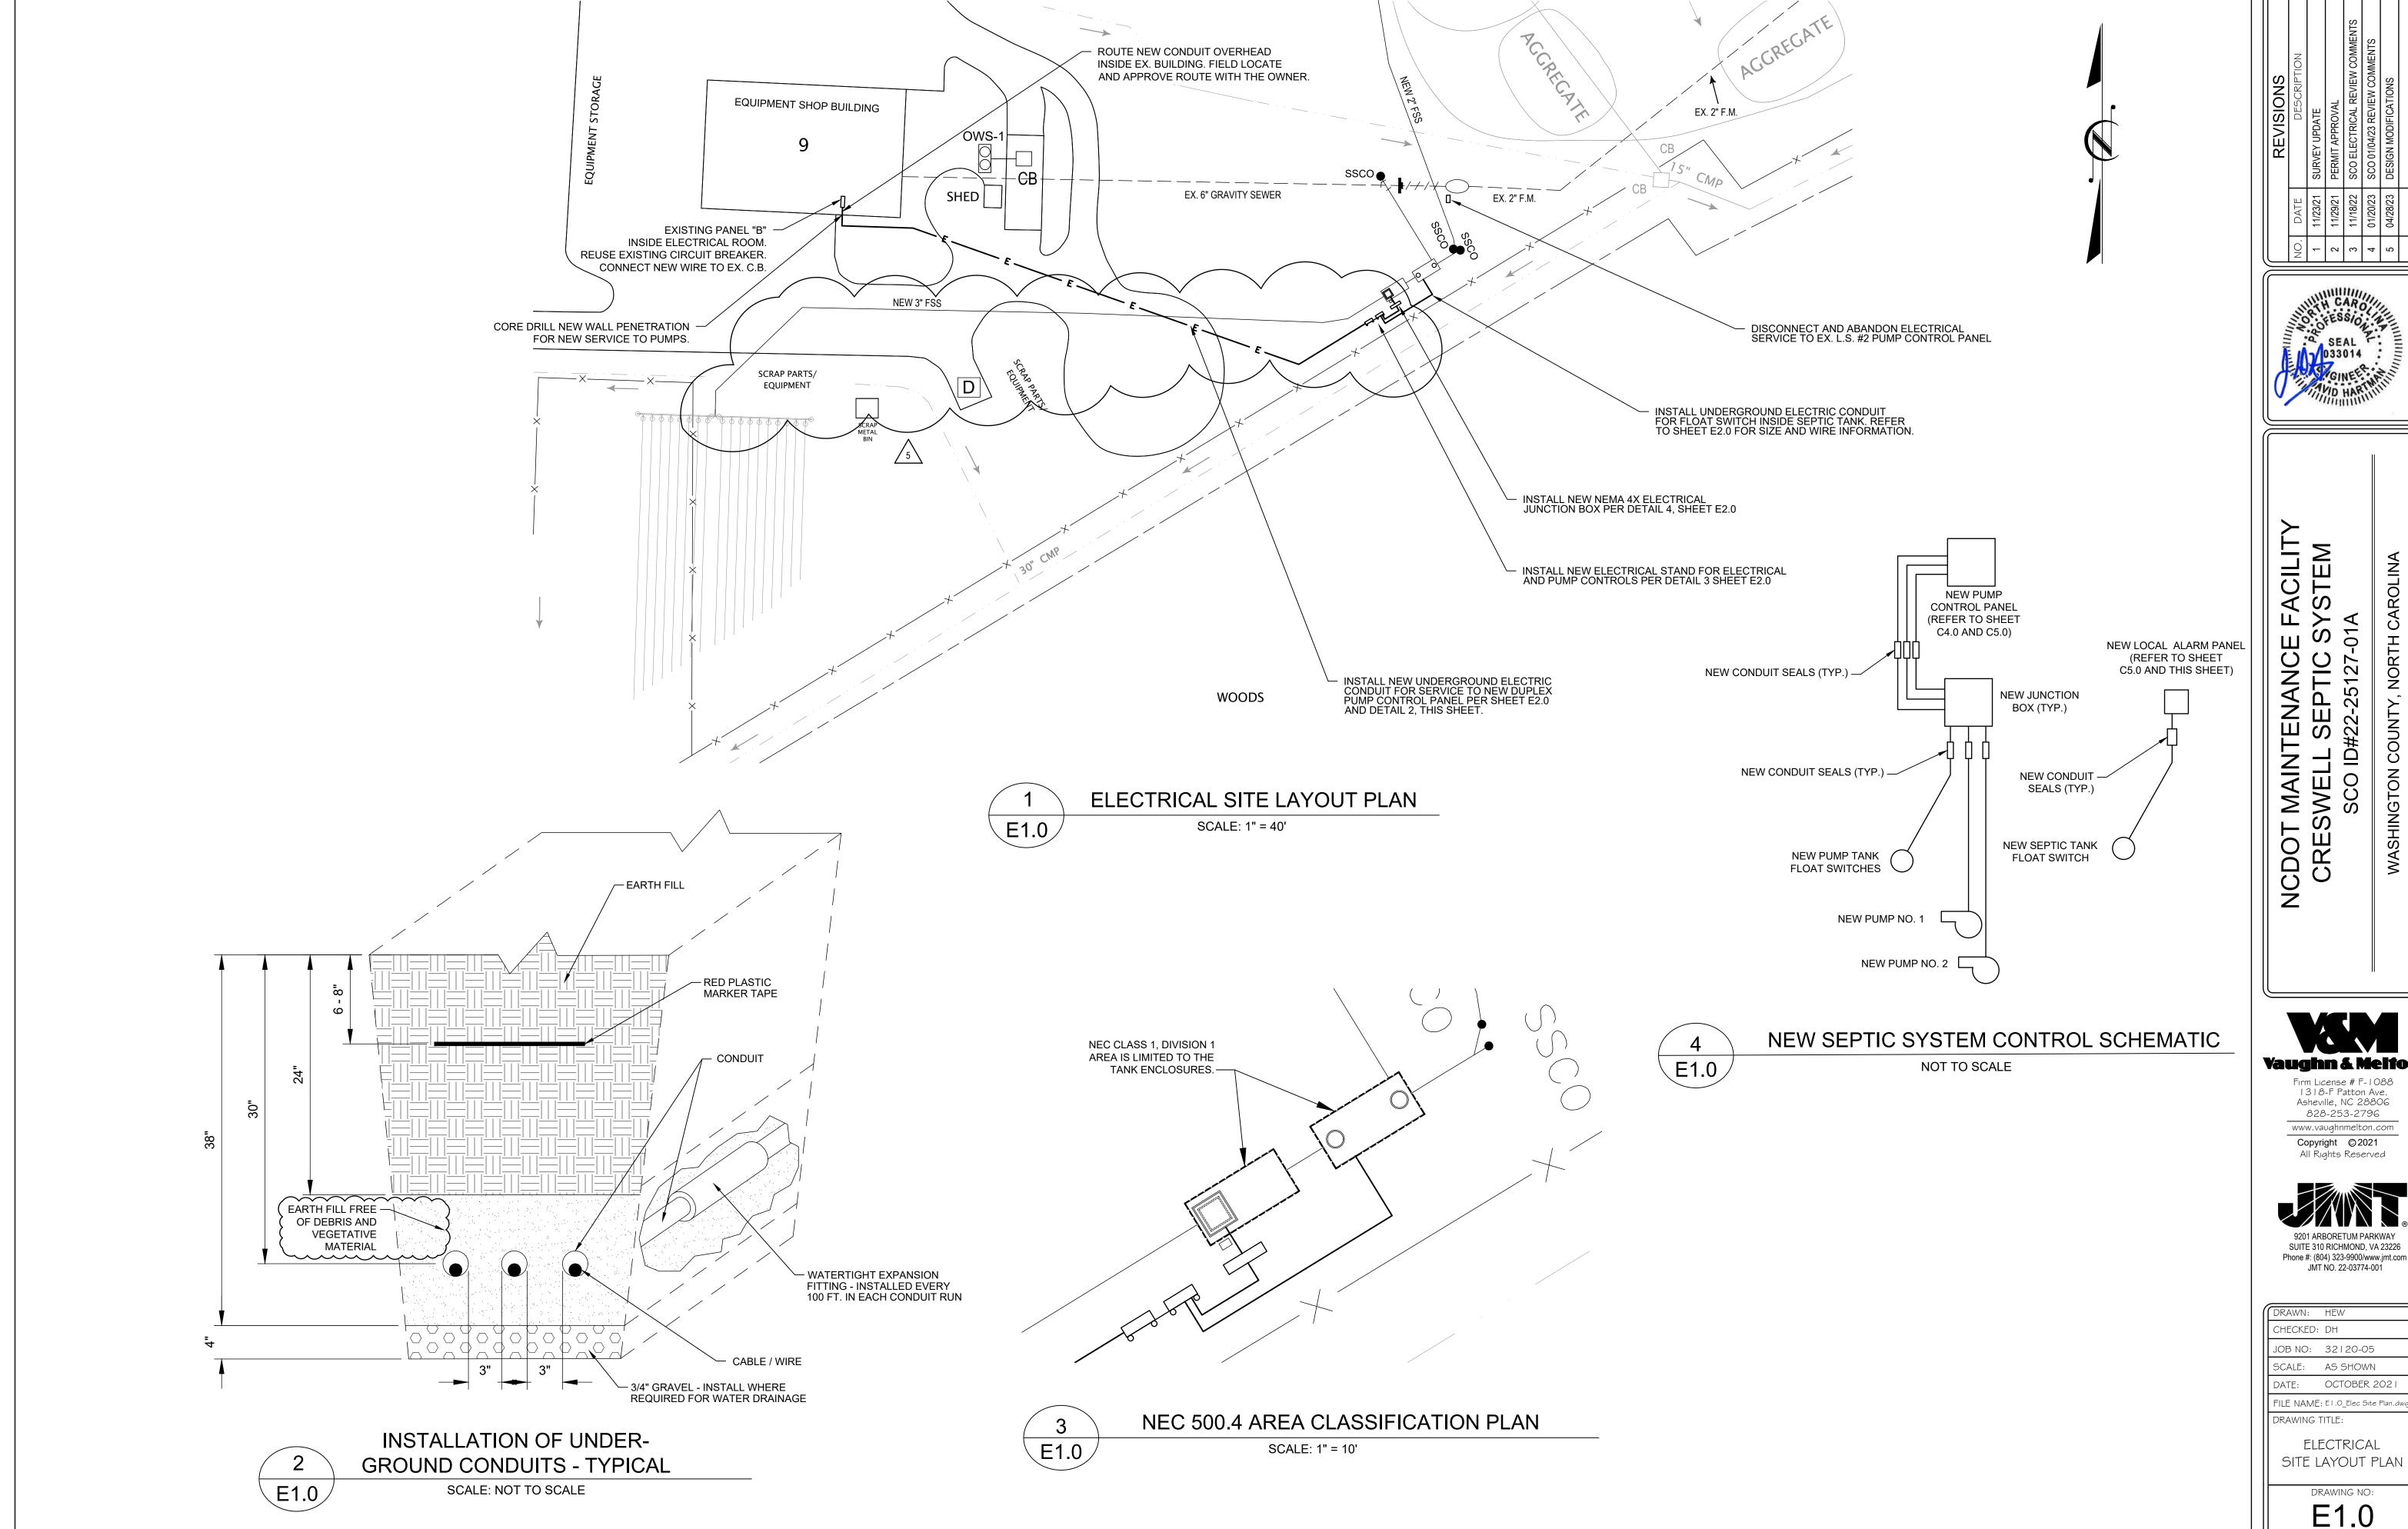


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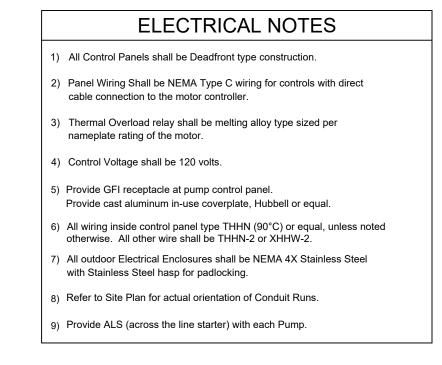
SUITE 310 RICHMOND, VA 23226

DRAWN: HEW CHECKED: DH JOB NO: 32120-05 SCALE: AS SHOWN DATE: OCTOBER 2021 FILE NAME: E1.0_Elec Site Plan.dwg DRAWING TITLE: ELECTRICAL SITE LAYOUT PLAN


DRAWING NO:



MANUFACTURER: MYER MODEL WHRIOH OR EQUAL

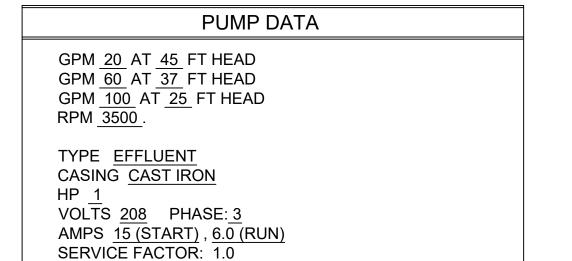

PUMP CON	NTROL PANEL
MAIN BRK. Motor BRK. Breaker (each)	50 amp 3 phase 4
Motor Controller NEMA size (TYP.)	20 amp
Motor Size Actual Hp. Design Hp.	1 HP 1 HP
Thermal OL type size	Melting alloy Per nameplate rating
120 volt outlet NEMA 5-15R	Power from Service. same
Junction Box Conduit Seals	¾", 1", 1.5" ¾", 1", 1.5"
Control wire Type	#12/2 SJO
Pump power cord Type	3-#10 SOOW
Seal Failure Thermal overload	3-#12 3-#12
N/A - Not Applicable	N/R - Not Required

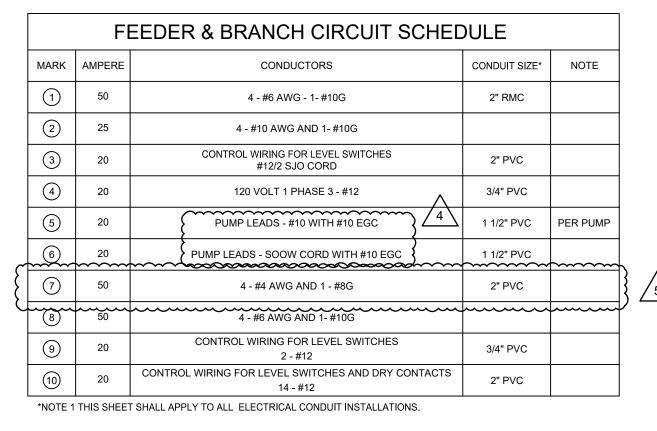

NOTES:


AND INSIDE PRE-CAST TANKS.

WET-WELL/TANK.

INSTALL RMC CONDUIT IN EXPOSED AREAS AND FOR ALL UNDERGROUND ELBOWS THAT TRANSITION TO PVC. USE PVC CONDUIT BELOW GROUND

ALL AREAS INSIDE THE WET/WELL/TANKS IS CLASSIFIED ACCORDING TO

2. SEAL GAS-TIGHT ALL ELECTRICAL CONDUIT OPENINGS INSIDE A

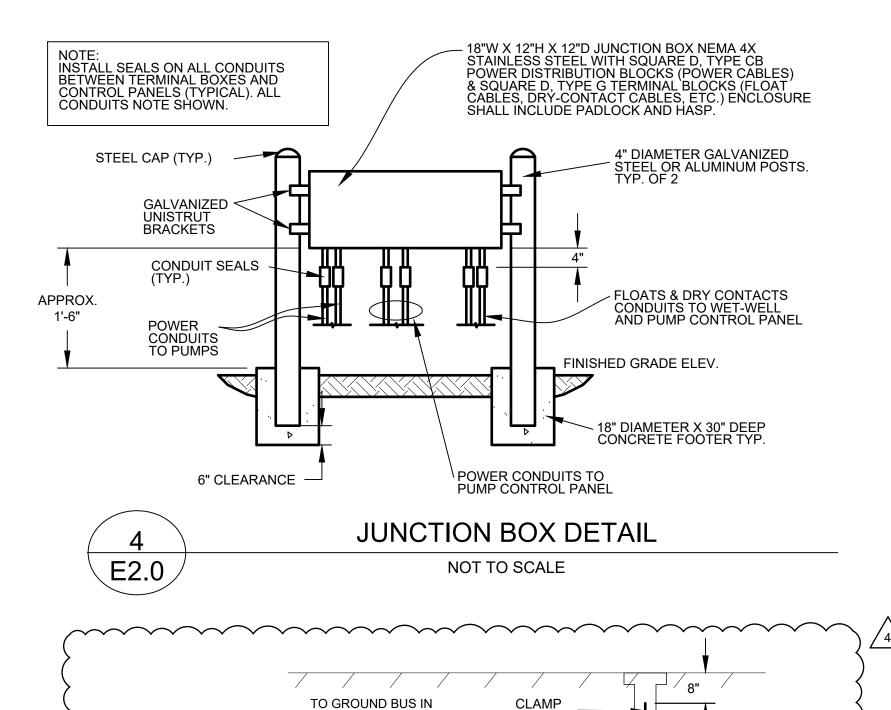

DISCONNECTING [

E2.0

(COPPER)

3/4" x 10'-0"

(NOTE 3)

COPPER-CLAD GROUND ROD

GROUNDING DETAIL


NOT TO SCALE


PERFORM GROUND RESISTANCE TEST AND PROVIDE ADDITIONAL GROUND RODS

AS REQUIRED TO ACHIEVE A GROUND RESISTANCE OF 25 OHMS OR LESS.

PROVIDE TEST WELL AT THE DRIVEN GROUND ROD(S). ALL GROUND CONNECTIONS SHALL BE ACCESSIBLE.

10'-0"

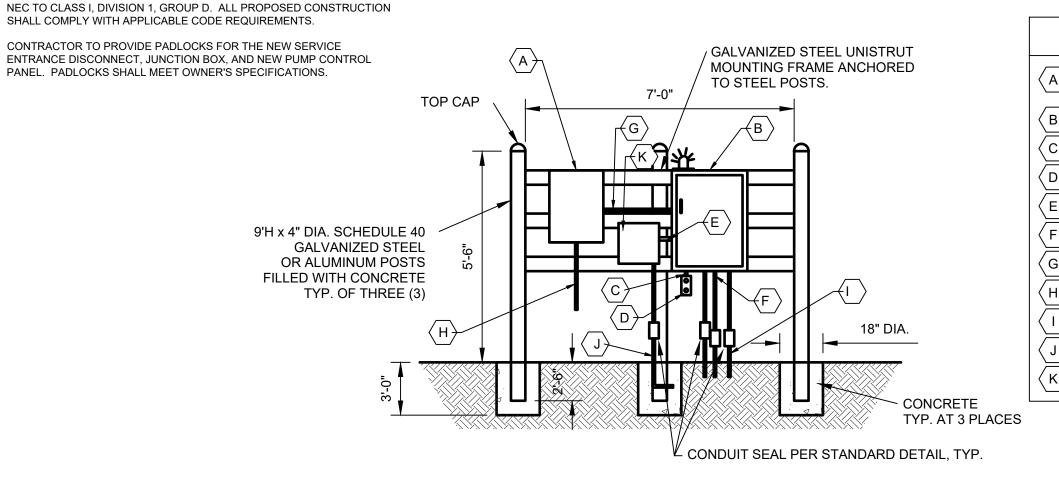


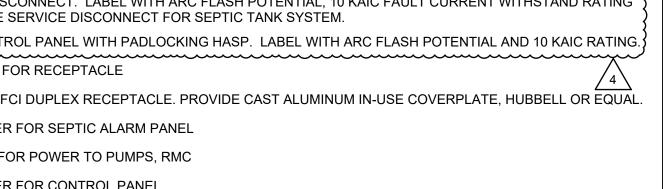

H > INCOMING SERVICE CONDUIT AND CONDUCTORS, RMC


CONDUIT FLOAT SWITCHES, RMC J > RMC CONDUIT TO SEPTIC TANK FLOAT SWITCH

ELEVATION - FRONT

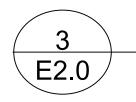

ELECTRICAL AND PUMP CONTROL PANEL MOUNTING DETAIL

NOT TO SCALE

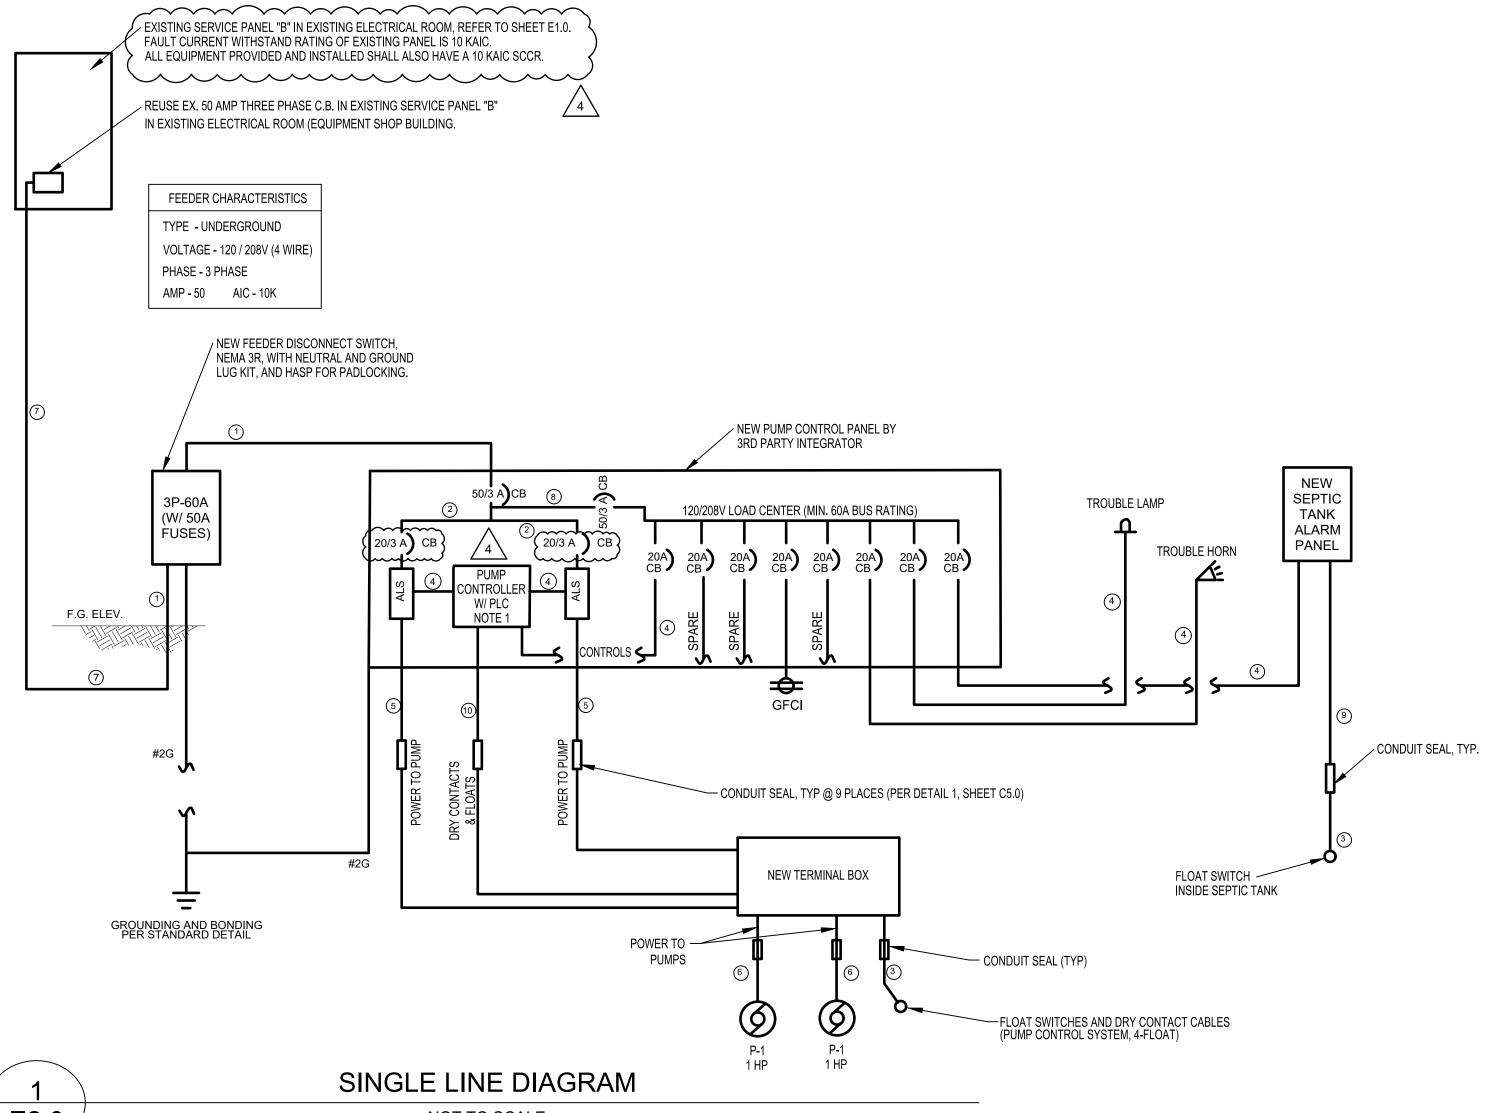

NOT TO SCALE NOTE: PLC CONTROLLER SHALL HAVE BATTERY BACKUP INTEGRAL TO CONTROLLER CABINET. CONTRACTOR TO INSTRUCT OWNER ON BATTERY TESTING AND REPLACEMENT REQUIREMENTS. ______

TANK SITE - DRAWING NOTES

A 🕻 SERVICE DISCONNECT. LABEL WITH ARC FLASH POTENTIAL, 10 KAIC FAULT CURRENT WITHSTAND RATING AND AS THE SERVICE DISCONNECT FOR SEPTIC TANK SYSTEM.

B >> PUMP CONTROL PANEL WITH PADLOCKING HASP. LABEL WITH ARC FLASH POTENTIAL AND 10 KAIC RATING. C > 3/4" C. RMC FOR RECEPTACLE

D > 120V, 20A GFCI DUPLEX RECEPTACLE. PROVIDE CAST ALUMINUM IN-USE COVERPLATE, HUBBELL OR EQUAL

E > RMC FEEDER FOR SEPTIC ALARM PANEL

F > CONDUITS FOR POWER TO PUMPS, RMC G > RMC FEEDER FOR CONTROL PANEL

K SEPTIC TANK ALARM PANEL

DRAWN: HEW CHECKED: DH JOB NO: 32120-05 SCALE: AS SHOWN DATE: OCTOBER 2021 FILE NAME: E2.0_Elec Details.dwg DRAWING TITLE:

ELECTRICAL DETAILS

DRAWING NO:

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REVISIONS

- 2 κ 4 i

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